
OFFICE OF EDUCATION SANITARY EJECTOR PUMPS AND SEWER PIPE REPLACEMENT DFCM PROJECT #05258200

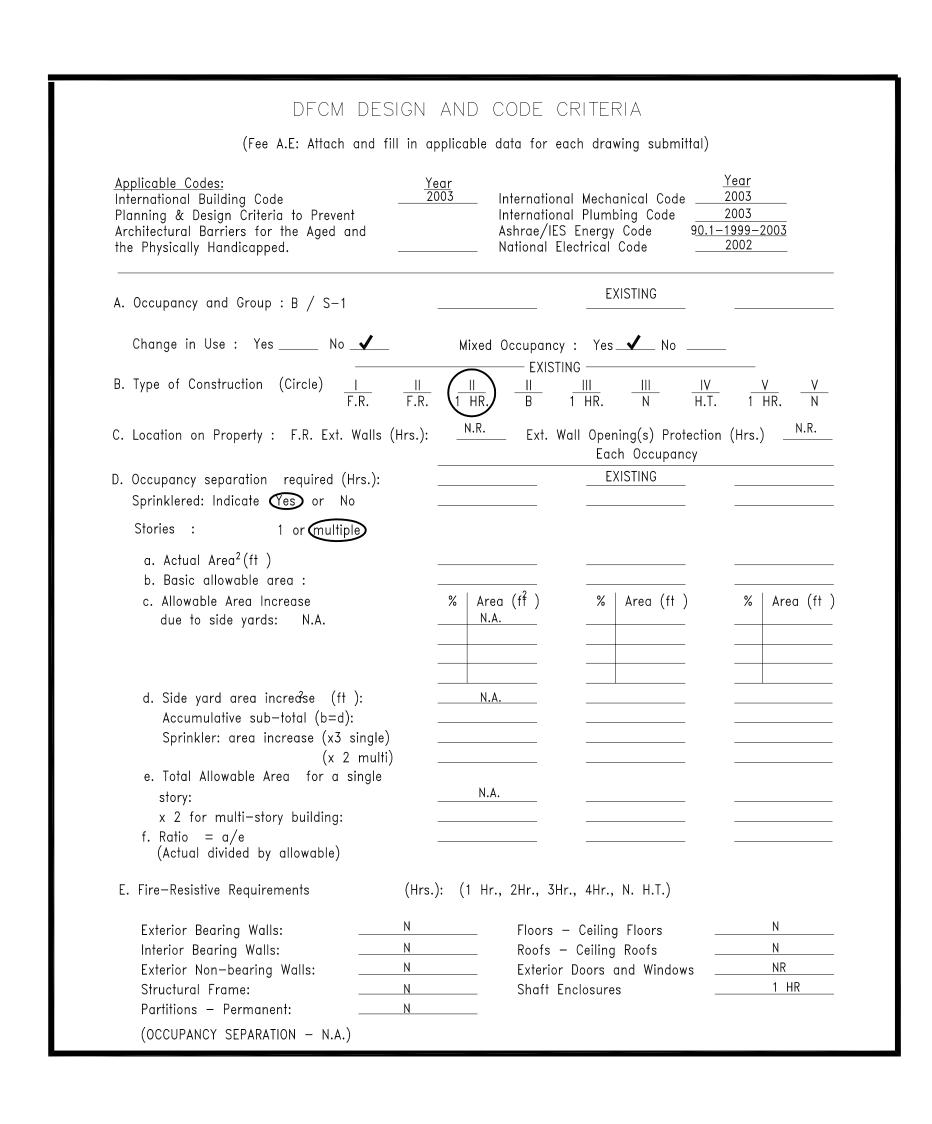



State of Utah—Department of Administrative Services

DIVISION OF FACILITIES CONSTRUCTION AND MANAGEMENT

4110 State Office Building / Salt Lake City, Utah 84114 / 538-3018

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PE-501 SEWER PIPING AND ELECTRICAL DETAILS & SCHEDULES

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		MECHANIC	AL LE	GE	END
SYMBOL	ABR.	DESCRIPTION	SYMBOL	ABR.	DESCRIPTION
GENERAL	TERM	NOLOGY	WET SIDE	CONT	INUED
B2		- DETAIL NUMBER DESIGNATION	 — —		UNION
1		- MECHANICAL EQUIPMENT DESIGNATION - EQUIPMENT ITEM DESIGNATION	Γ		MANUAL ACTUATOR (BALL, BUTTERFLY, NEEDLE, ETC. VALVES)
À		REVISION DESIGNATOR AND NUMBER			MANUAL ACTUATOR (GATE, GLOBE, S&D, OS&Y, ETC. VALVES)
<u>(1)</u>		KEY NOTE DESIGNATOR AND NUMBER			OUD, OOUT, ETO. VALVEO)
•	POC	POINT OF CONNECTION			GATE VALVE
\bigcirc	POR	POINT OF REMOVAL			GLOBE VALVE - STRAIGHT PATTERN
AFF		ABOVE FINISHED FLOOR			CHECK VALVE
MC		MECHANICAL CONTRACTOR	—ф—	BV	BALL VALVE
CC		CONTROL CONTRACTOR	7		STRAINER
EC		ELECTRICAL CONTRACTOR	N. T.		STRAINER W/ PLUGGED BLOW OFF
NIC		NOT IN CONTRACT	-		DIRECTION OF FLOW
NTS		NOT TO SCALE	—		PITCH DOWN
С		COMMON	0		ELBOW UP
NC		NORMALLY CLOSED	C		ELBOW DOWN
NO		NORMALLY OPEN	<u> </u>		TEE UP
=					TEE DOWN
WET SIDE			(E)		EXISTING
		EXISTING PIPING TO BE REMOVED	(N)		NEW
		EXISTING PIPING TO REMAIN			
		NEW PIPING			
		PIPE CAP OR PLUG			
		CULINARY COLD WATER			
—ss—		SANITARY SEWER			
— v —		VENT PIPING			
— F —		FIRE LINE			

State of Utah Department of Administrative Services



GENERAL NOTES:

CODE.

COMPLIANCE.

STANDARDS AND SPECIFICATIONS.

PLUMBING INFORMATION IS NOT LIMITED TO THE DRAWINGS.

A - DRAWINGS AND SPECIFICATIONS HAVE BEEN PREPARED TO

CONTRACTOR SHALL BE RESPONSIBLE FOR INFORMATION FROM DFCM

SUPPLEMENT EACH OTHER AND THEY SHALL BE INTERPRETED AS AN INTEGRAL UNIT WITH ITEMS SHOWN AND NOTED ON ONE AND NOT THE

OTHER BEING FURNISHED AND INSTALLED AS THOUGH SHOWN AND CALLED OUT IN ALL PLACES. ITEMS IN SPECIFICATIONS OR DRAWINGS

LISTED WHICH ARE DIFFERING IN EFFICIENCY OR QUALITY SHALL BE

INSTALLATION OF THE SYSTEMS ACCORDING TO THE TRUE INTENT AND

C - THE CONTRACTOR SHALL INSTALL ALL EQUIPMENT WITH PROPER SERVICE ACCESS AND CLEARANCES ACCORDING TO MANUFACTURERS RECOMMENDATIONS. THE CONTRACTOR SHALL REVIEW SUPPLIERS BID

SPECIFICATIONS, SCHEDULES, AND DESIGN INTENT (ALL EQUIPMENT AND METHODS). THE CONTRACTOR SHALL REMOVE AND REINSTALL

INSTALLATION INSTRUCTIONS FOR SIZES, METHODS, ACCESSORIES, AND CLEARANCES IN SPACE AVAILABLE PRIOR TO BIDDING PROJECT

E - ANYTHING NOT CLEAR OR IN CONFLICT WILL BE EXPLAINED BY

ANY AND ALL ALTERATIONS TO THE SYSTEM SHOWN SHALL BE THE

RESPONSIBILITY OF THIS CONTRACTOR. ENGINEER SHALL BE NOTIFIED

CONTRACTOR SHALL FIELD VERIFY ALL DIMENSIONS AND LOCATIONS.

EVERY OFFSET, BEND, OR ELBOW NECESSARY FOR THE COMPLETE

PLUMBING EQUIPMENT AND PIPING SHALL BE FIELD VERIFIED AND

THE INSTRUCTION TO "PROVIDE" ALSO INCLUDES INSTALLATION.

AND DISCREPANCIES SHALL BE BROUGHT TO THE ENGINEERS

SUPPLIERS SHALL REVIEW ALL DRAWINGS AND THE SPECIFICATIONS PRIOR TO SUBMITTING PRICES TO THE CONTRACTOR. ALL QUESTIONS

CONTRACTOR SHALL THOROUGHLY REVIEW AND SIGN SUBMITTALS

SPECIFICATIONS, OR SCHEDULES SHALL BE CLEARLY NOTED AND EXPLAINED. SUBMITTAL REVIEW AND ACCEPTANCE IS FOR DESIGN

ALL MECHANICAL SHALL BE INSTALLED AND CONFORM TO THE 2003

PRIOR TO ENGINEERS REVIEW. SUPPLIERS SHALL HIGHLIGHT OR MARK

FOR COMPLETENESS AND COMPLIANCE TO THE SPECIFICATIONS

ALL INFORMATION REQUIRED TO SHOW COMPLIANCE TO THE

SPECIFICATIONS. ALL REQUESTED EXCEPTIONS TO THE

CONCEPT ONLY, AND DOES NOT AT ANY TIME RELIEVE THE CONTRACTOR OF RESPONSIBILITY TO MEET SPECIFICATIONS,

EDITION OF THE IMC AND IPC WITH UTAH ANNOTATIONS.

G-4 THE WORKING DRAWINGS ARE DIAGRAMMATIC. THEY DO NOT SHOW

INSTALLATION IN THE SPACE PROVIDED. ALL LOCATIONS FOR

HELD TO THE GREATEST OF: EFFICIENCY, QUALITY OR GOVERNING

B - THE CONTRACTOR WILL BE HELD RESPONSIBLE FOR THE

PACKAGES FOR COMPLETENESS AND COMPLIANCE TO THE

CORRECTLY AT HIS OWN EXPENSE ANY EQUIPMENT NOT IN

D - THE CONTRACTOR SHALL CONSULT MANUFACTURERS

MAKING APPLICATION TO THE ENGINEER IN WRITING.

IN WRITING PRIOR TO CHANGES.

COORDINATED WITH ALL DRAWINGS.

ATTENTION PRIOR TO BIDDING.


CAPACITIES, OR DESIGN INTENT.

MEANING OF THE CONTRACT DOCUMENTS.

Division of Facilities Construction & Management 4110 State Office Building Salt Lake City, Utah 84114 Phone: (801) 538 - 3018 Fax: (801) 538 - 3267

Internet: http://www.dfcm.state.ut.us

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PROJECT NAME & ADDRESS

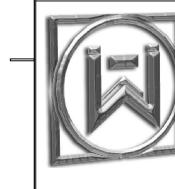OFFICE OF EDUCATION **SANITARY EJECTOR PUMPS & SEWER** PIPE REPLACEMENT

DFCM No. 05258200

S.L.C., UTAH

MARK	DATE	REVISION


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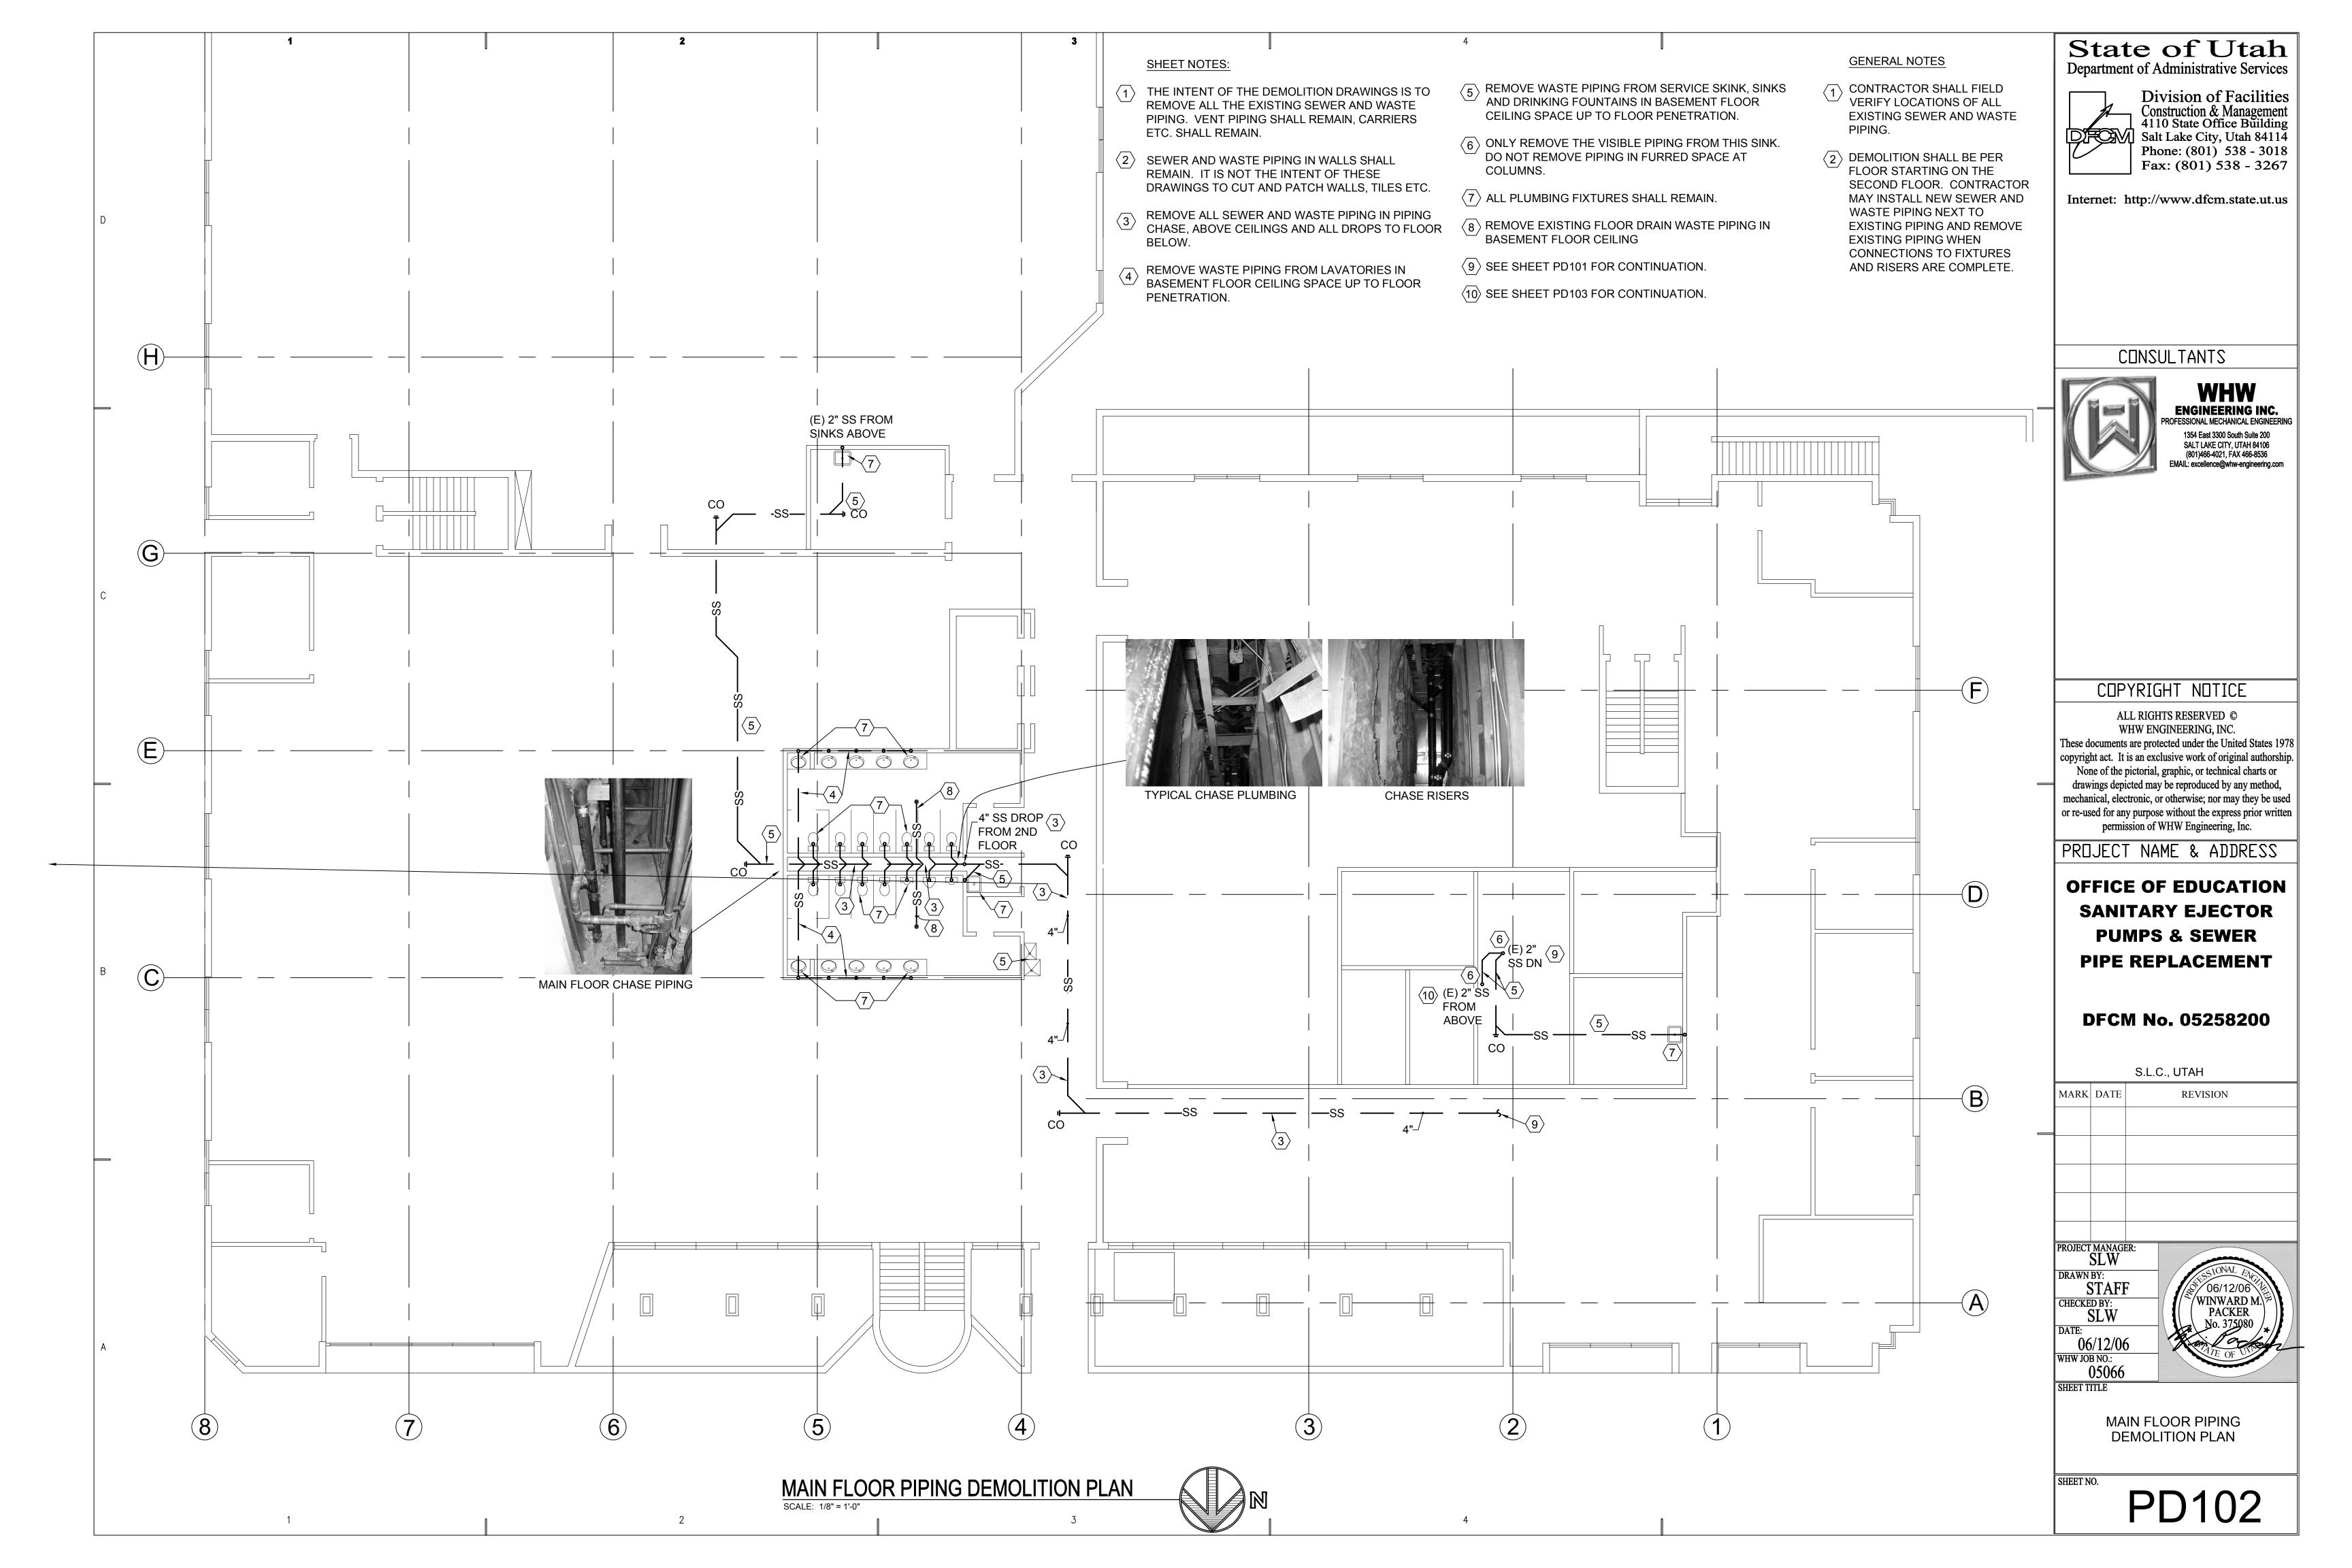
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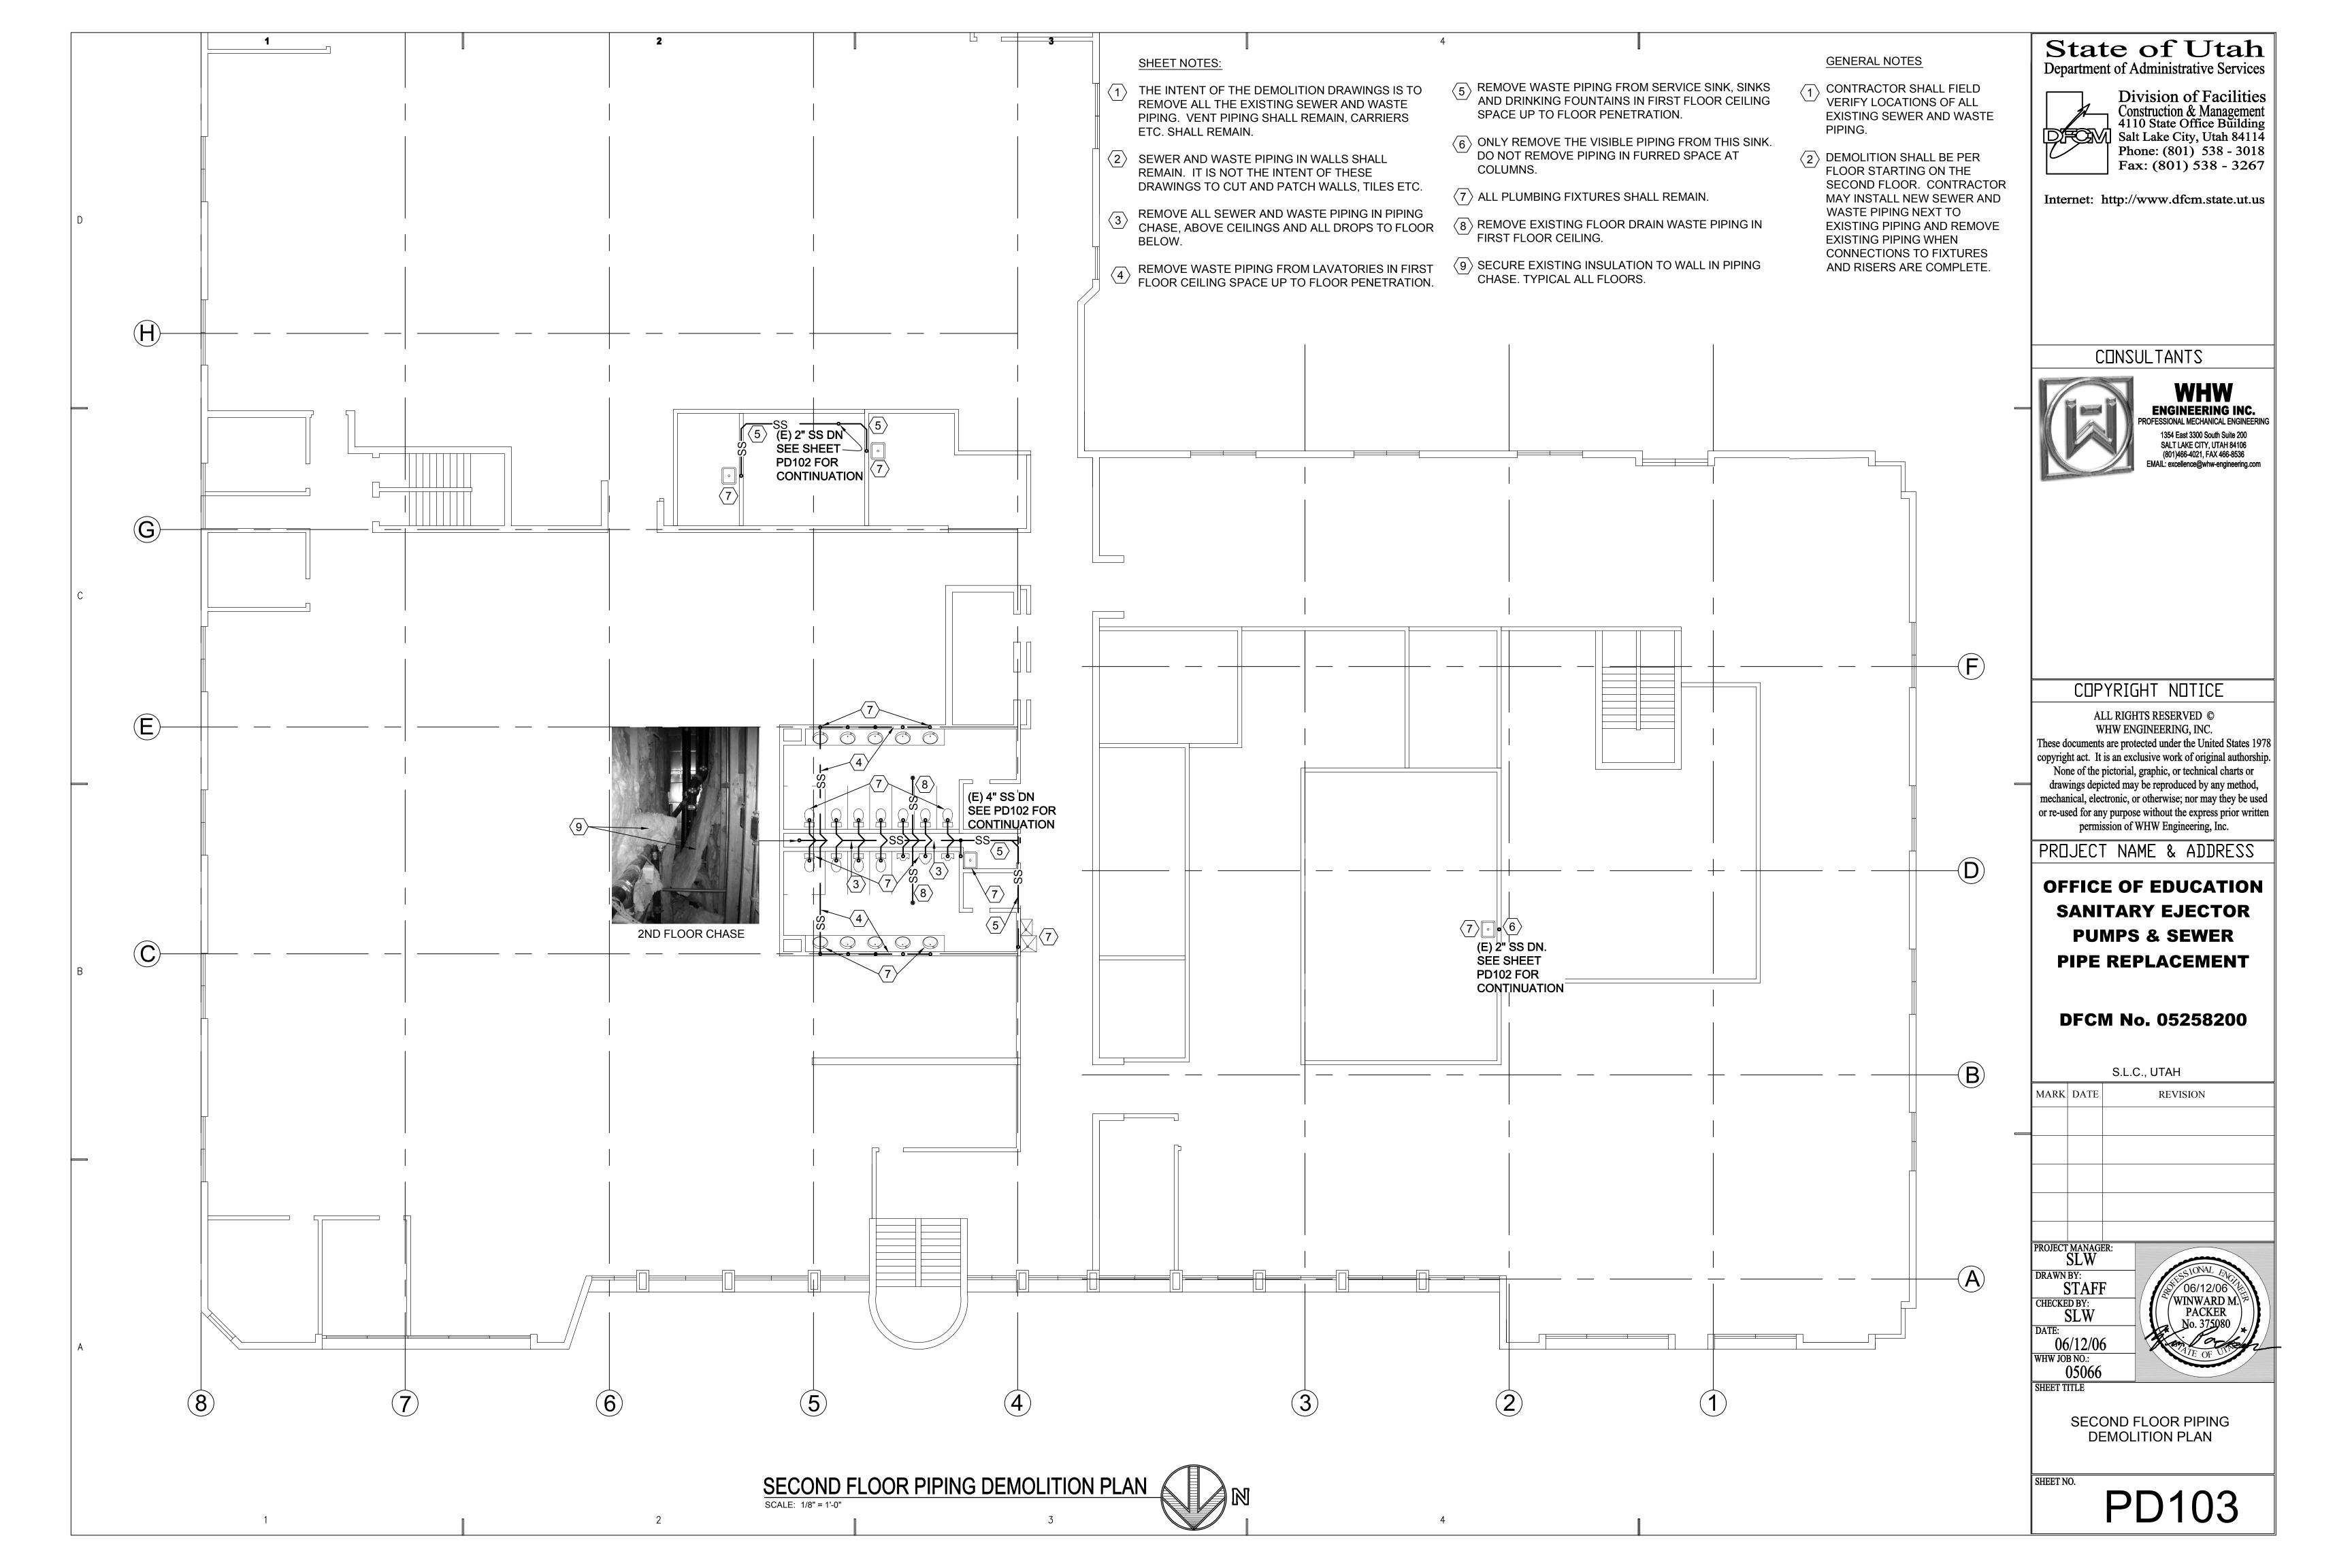
SHEET TITLE


GENERAL PLUMBING NOTES AND LEGEND

P001






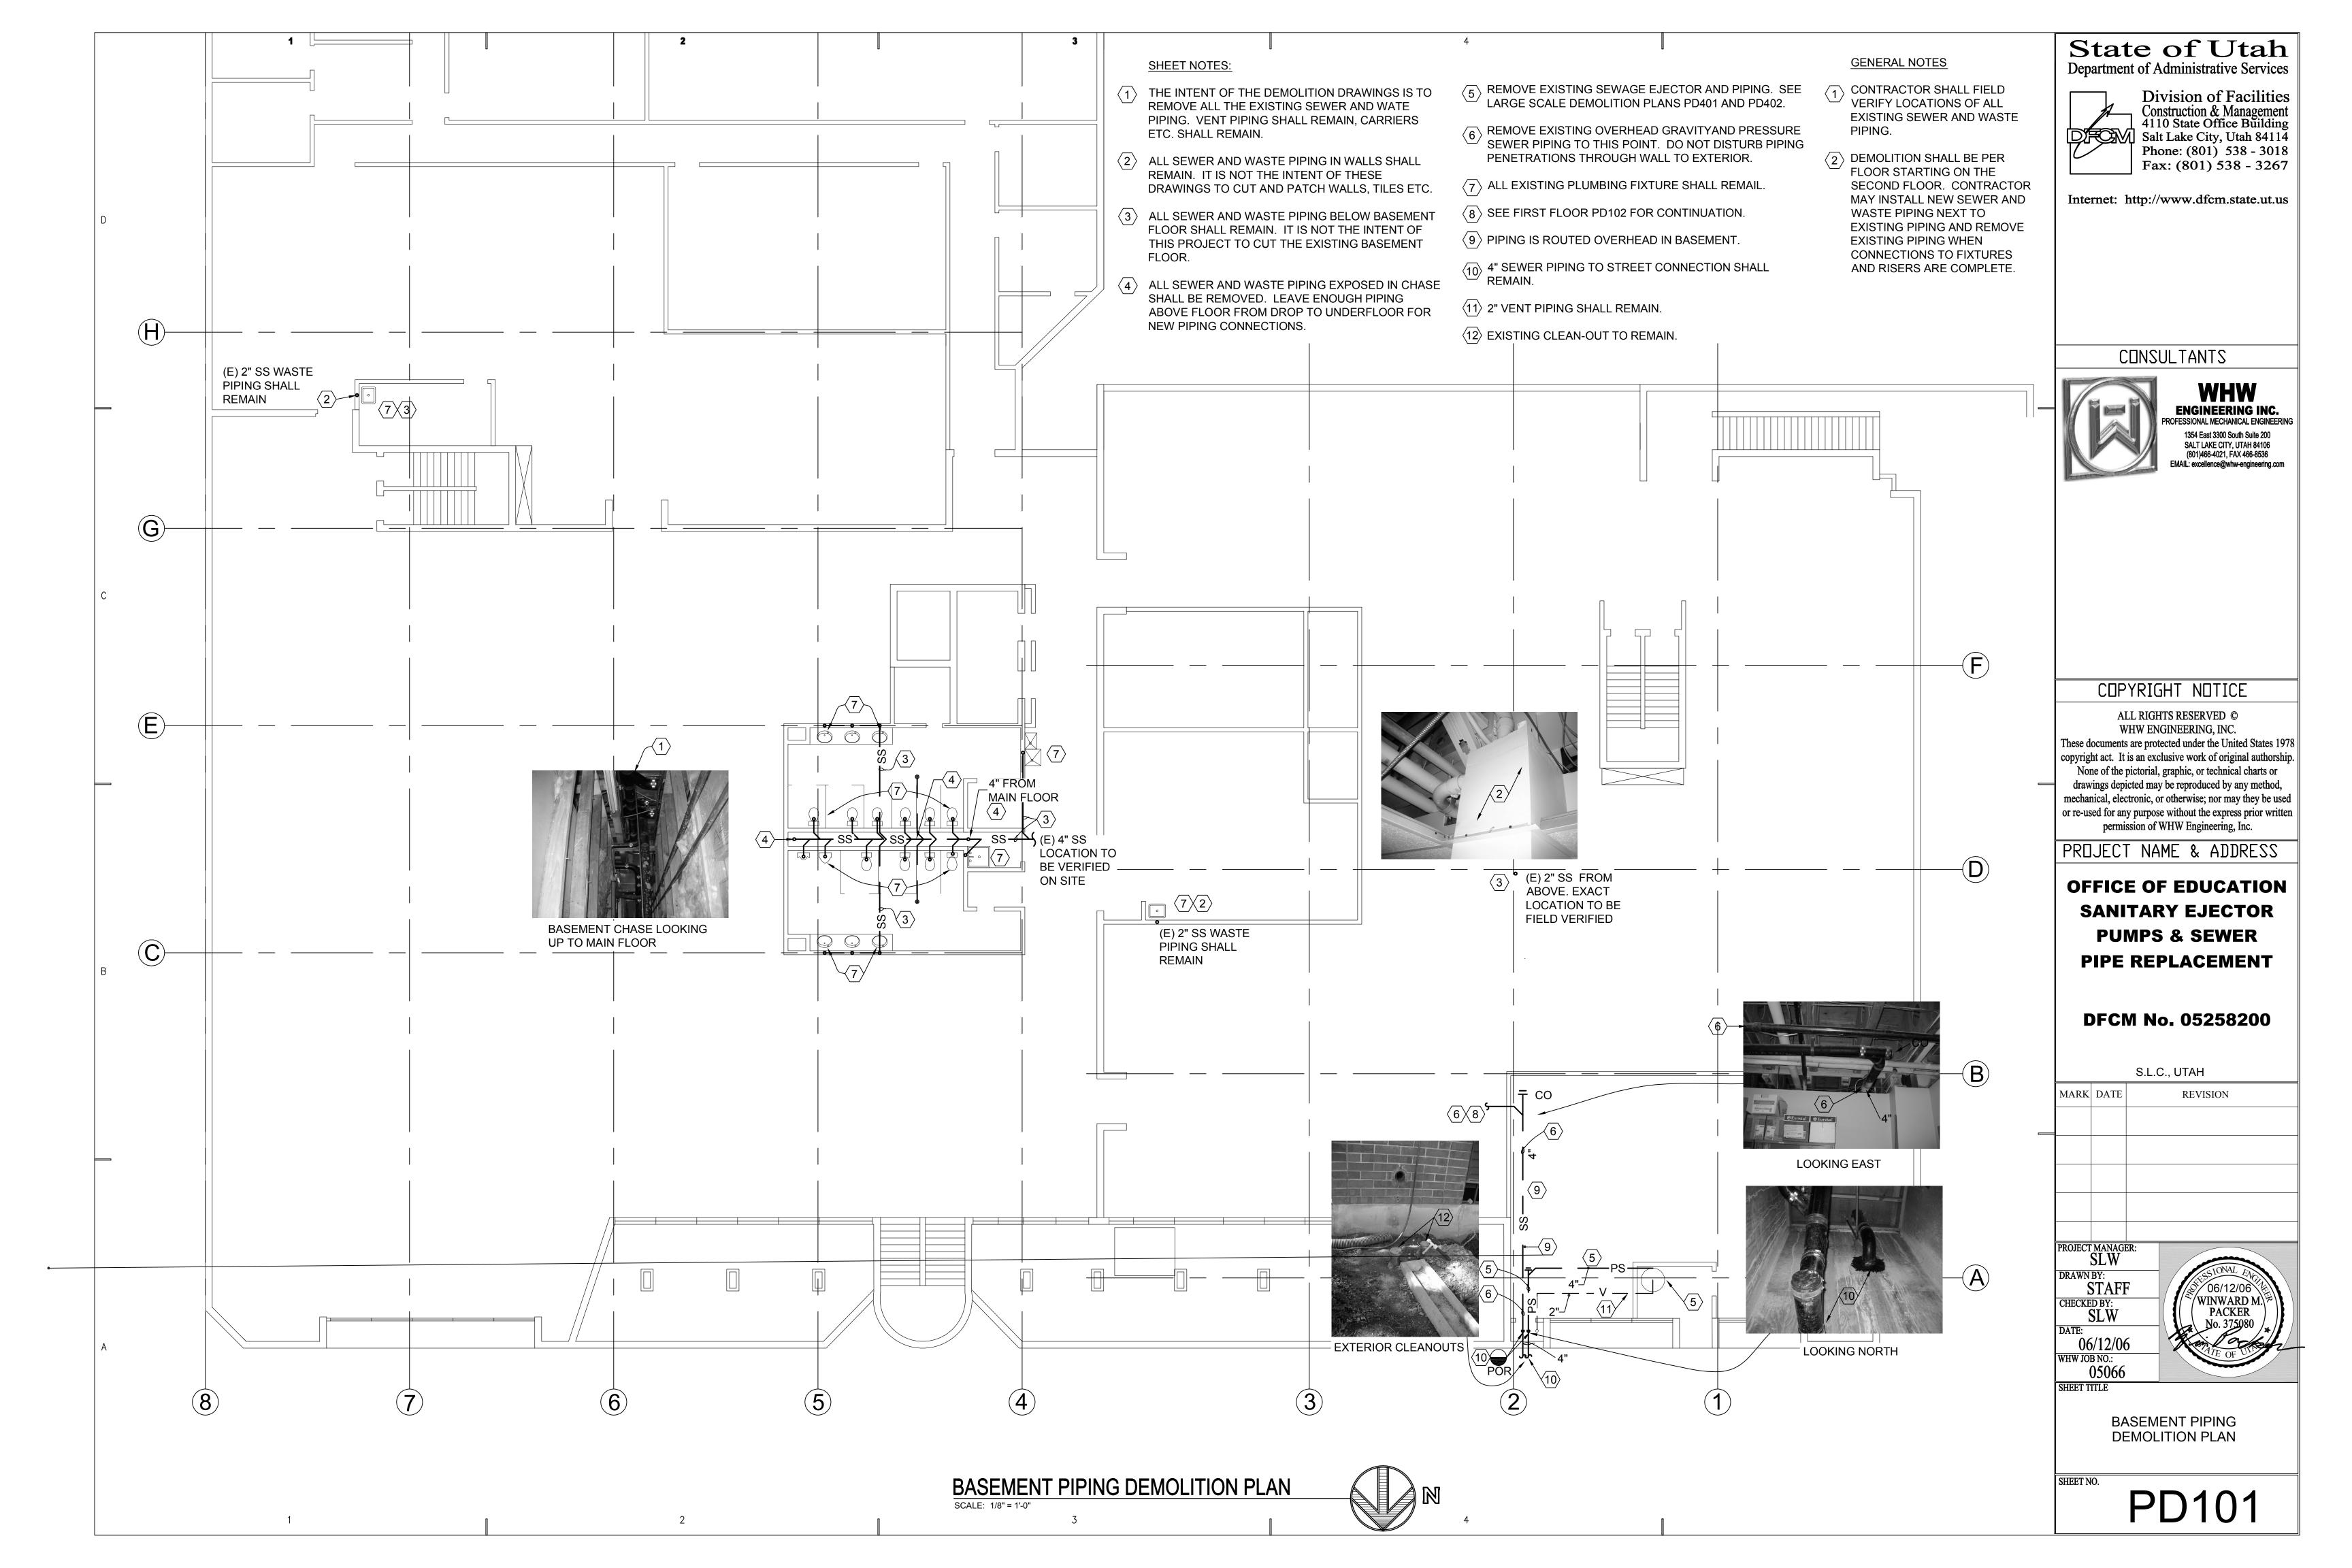

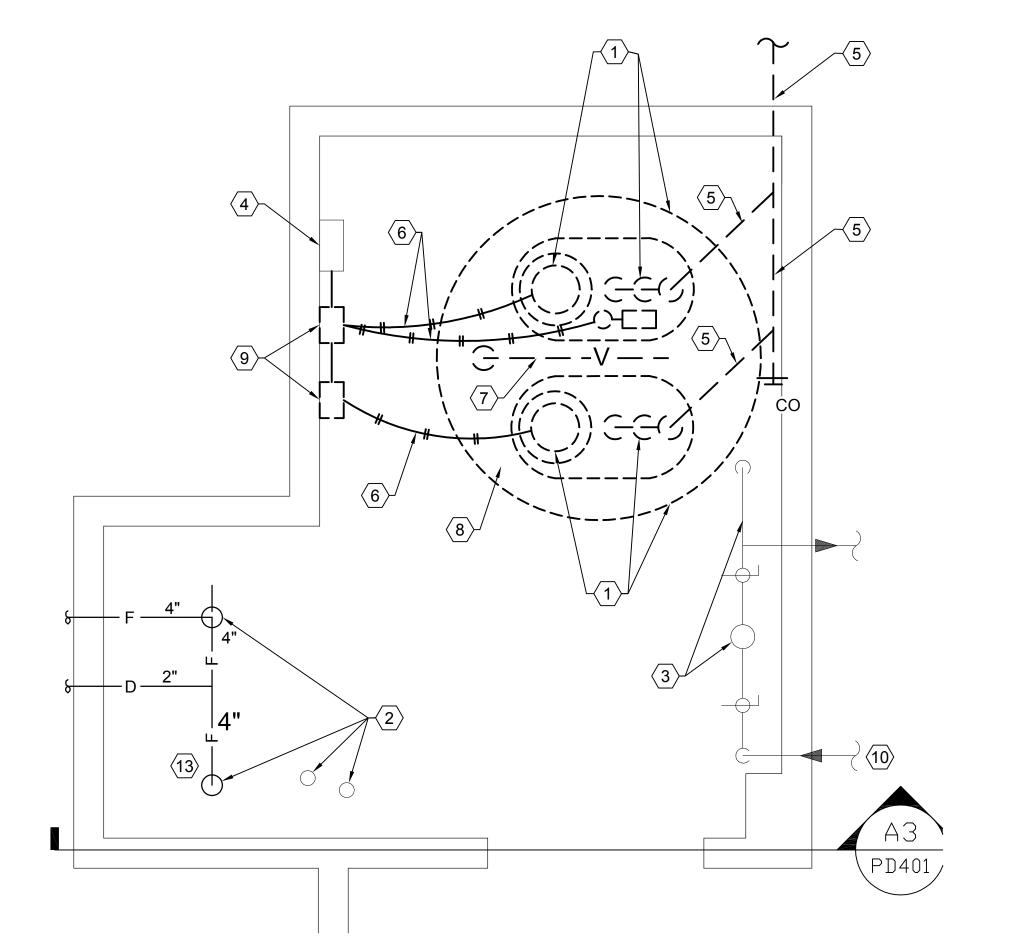

BASEMENT EJECTOR ROOM PIPING DEMOLITION PLAN

SCALE: 3/4" = 1'-0"

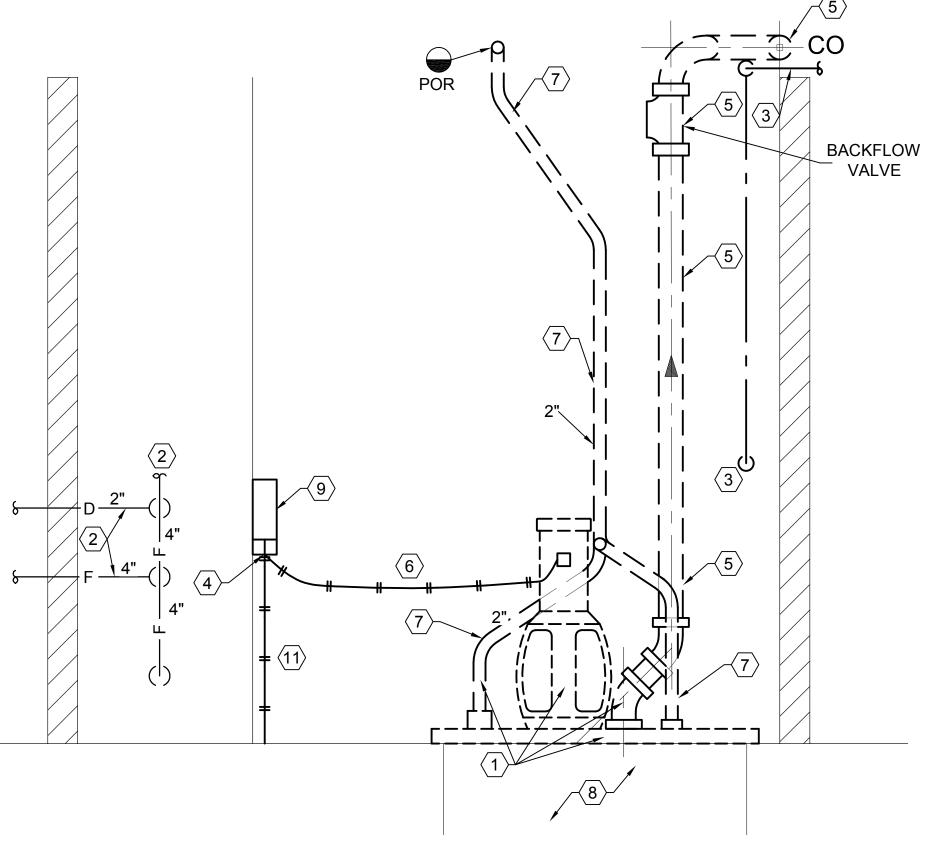

BASEMENT EJECTOR ROOM PIPING DEMOLITION ELEVATION-LOOKING EAST

SCALE: 3/4" = 1'-0"

SHEET NOTES

- 1 REMOVE EXISTING SEWAGE EJECTOR PUMPS, COVER, CONTROLS, ELECTRICAL, PIPING ETC.
- $\langle 2 \rangle$ EXISTING FIRE PROTECTION PIPING RISERS, PIPING ETC. SHALL REMAIN. PROTECT DURING CONSTRUCTION.
- $\langle 3 \rangle$ EXISTING CULINARY WATER PRV STATION SHALL REMAIN. PROTECT DURING CONSTRUCTION.
- $\langle 4 \rangle$ EXISTING DISCONNECT SHALL REMAIN.
- REMOVE EXISTING 4" PUMPED SEWER PIPING, AND BACKFLOW VALVES. SEE A1/MD402..
- $\langle 6 \rangle$ REMOVE EXISTING FLEX CONDUIT AND WIRING.
- $\overline{7}$ REMOVE EXISTING 2" VENT PIPING.
- $\langle 8
 angle$ EXISTING SUMP SHALL REMAIN.
- $\langle 9 \rangle$ REMOVE EXISTING SEWAGE PUMP STARTERS.
- (10) CULINARY WATER SUPPLY TO PRV STATION SHALL REMAIN.
- (11) EXISTING POWER SUPPLY FROM FLOOR SHALL REMAIN.

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PROJECT NAME & ADDRESS

OFFICE OF EDUCATION SANITARY EJECTOR **PUMPS & SEWER** PIPE REPLACEMENT

DFCM No. 05258200


S.L.C., UTAH

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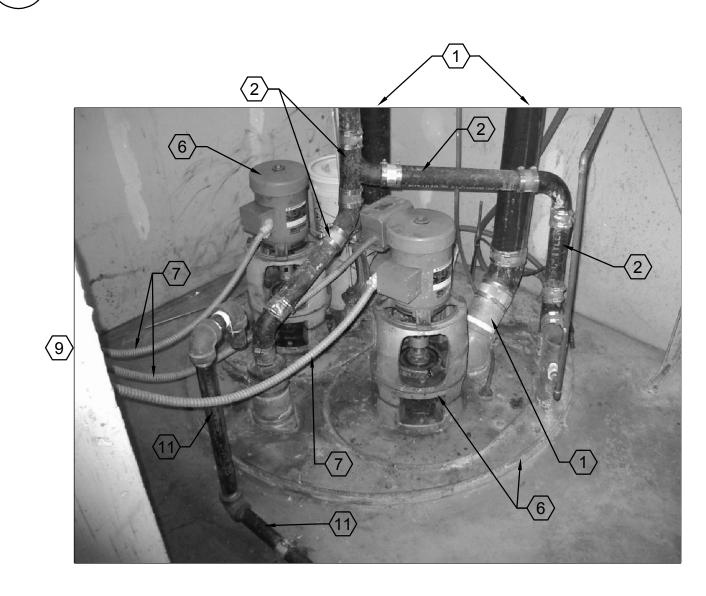
WHW JOB NO.:

05066


LARGE SCALE EJECTOR ROOM DEMOLITION PLANS AND ELEVATION

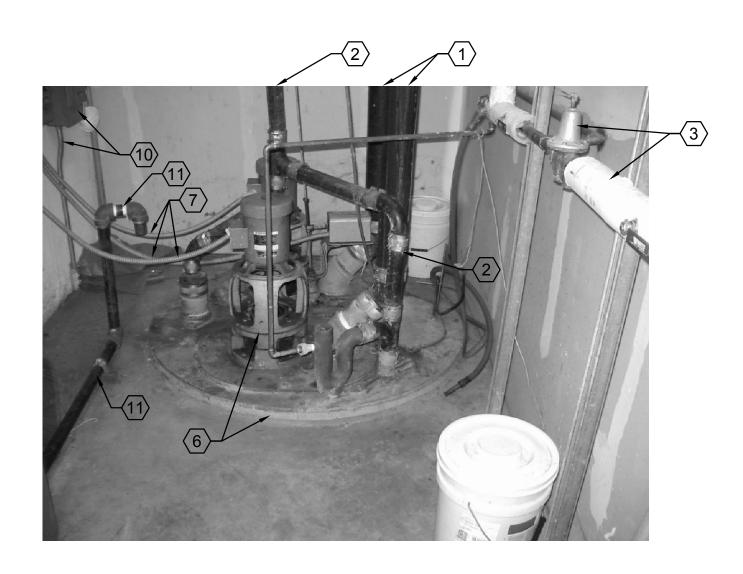


SEWAGE EJECTOR PUMP DEMOLITION
SCALE: NONE




SEWAGE EJECTOR PUMP, PIPING, AND CONTROLS

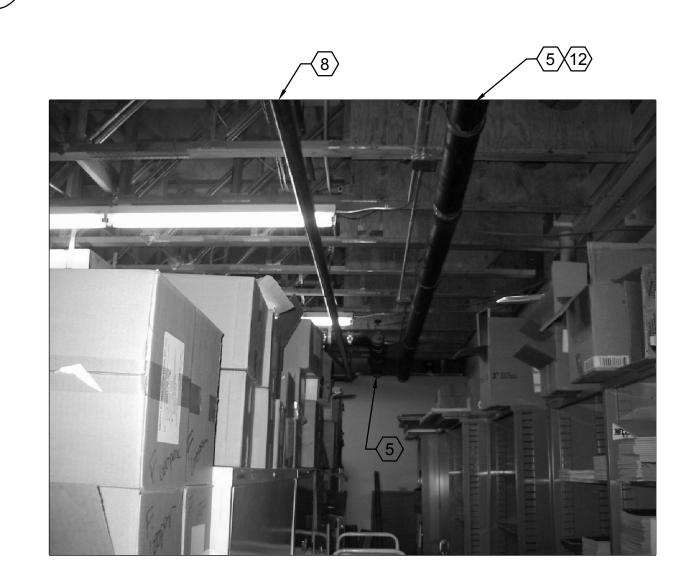

BASEMENT AREA-LOOKING NORTH

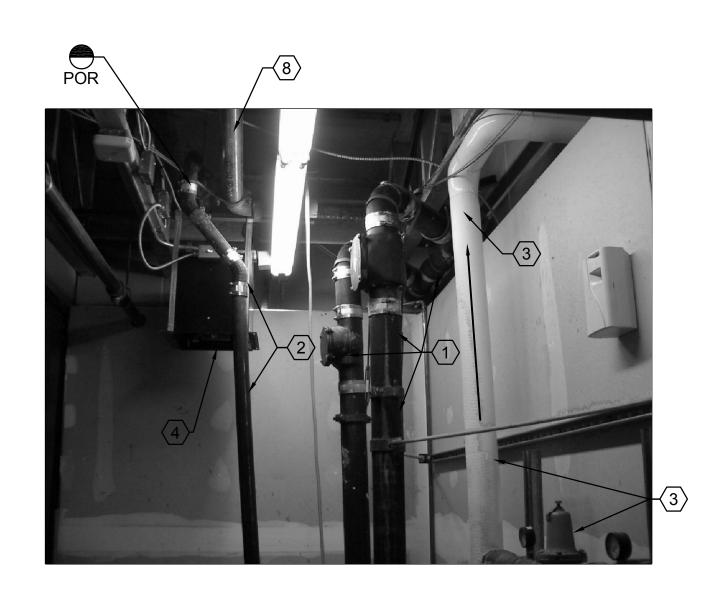

SEWAGE EJECTOR PUMPED PIPING-LOOKING EAST
SCALE: NONE

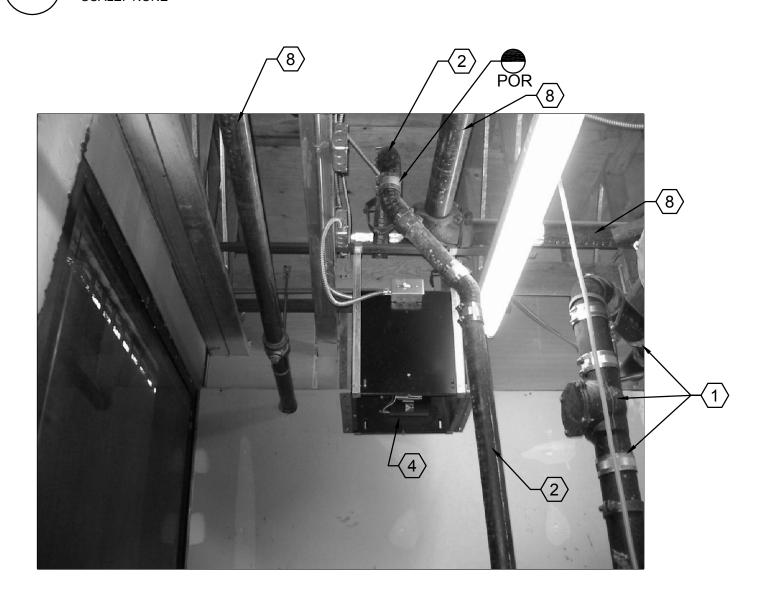

SEWAGE EJECTOR ROOM-LOOKING EAST




BASEMENT AREA-LOOKING EAST

SHEET NOTES

- 1 REMOVE EXISTING 4" C.I. SEWER PUMPED PIPING INCLUDING BACK FLOW VALVES.
- $race{2}$ REMOVE EXISTING 2" C.I. VENT PIPING TO POINT SHOWN.
- (3) EXISTING CULINARY PRV STATION AND PIPING SHALL REMAIN. PROTECT DURING CONSTRUCTION.
- $\langle 4 \rangle$ EXISTING EXHAUST FAN SHALL REMAIN.
- 5 REMOVE EXISTING GRAVITY AND PUMPED SEWER PIPING IN BASEMENT.
- $\langle 6 \rangle$ REMOVE EXISTING SUMP COVER, PUMPS, PIPING, CONTROLS, ETC.
- 7 REMOVE EXISTING FLEX CONDUIT TO EXISTING PUMPS AND CONTROLS.
- $\langle 8 \rangle$ FIRE PROTECTION PIPING SHALL REMAIN.
- (9) REMOVE EXISTING STARTERS, DISCONNECT SHALL REMAIN.
- (10) POWER WIRING AND CONDUIT TO DISCONNECT SHALL REMAIN.
- (11) FIRE RISER DRAIN PIPING SHALL BE REMOVED DURING CONSTRUCTION AND REPLACED AFTER NEW EJECTOR INSTALLATION.
- $\langle 12 \rangle$ SEE A3 THIS SHEET FOR CONTINUATION.
- $\langle 13 \rangle$ SEE A1 THIS SHEET FOR CONTINUATION.

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PROJECT NAME & ADDRESS

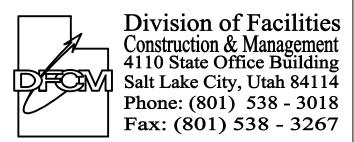
OFFICE OF EDUCATION **SANITARY EJECTOR PUMPS & SEWER** PIPE REPLACEMENT


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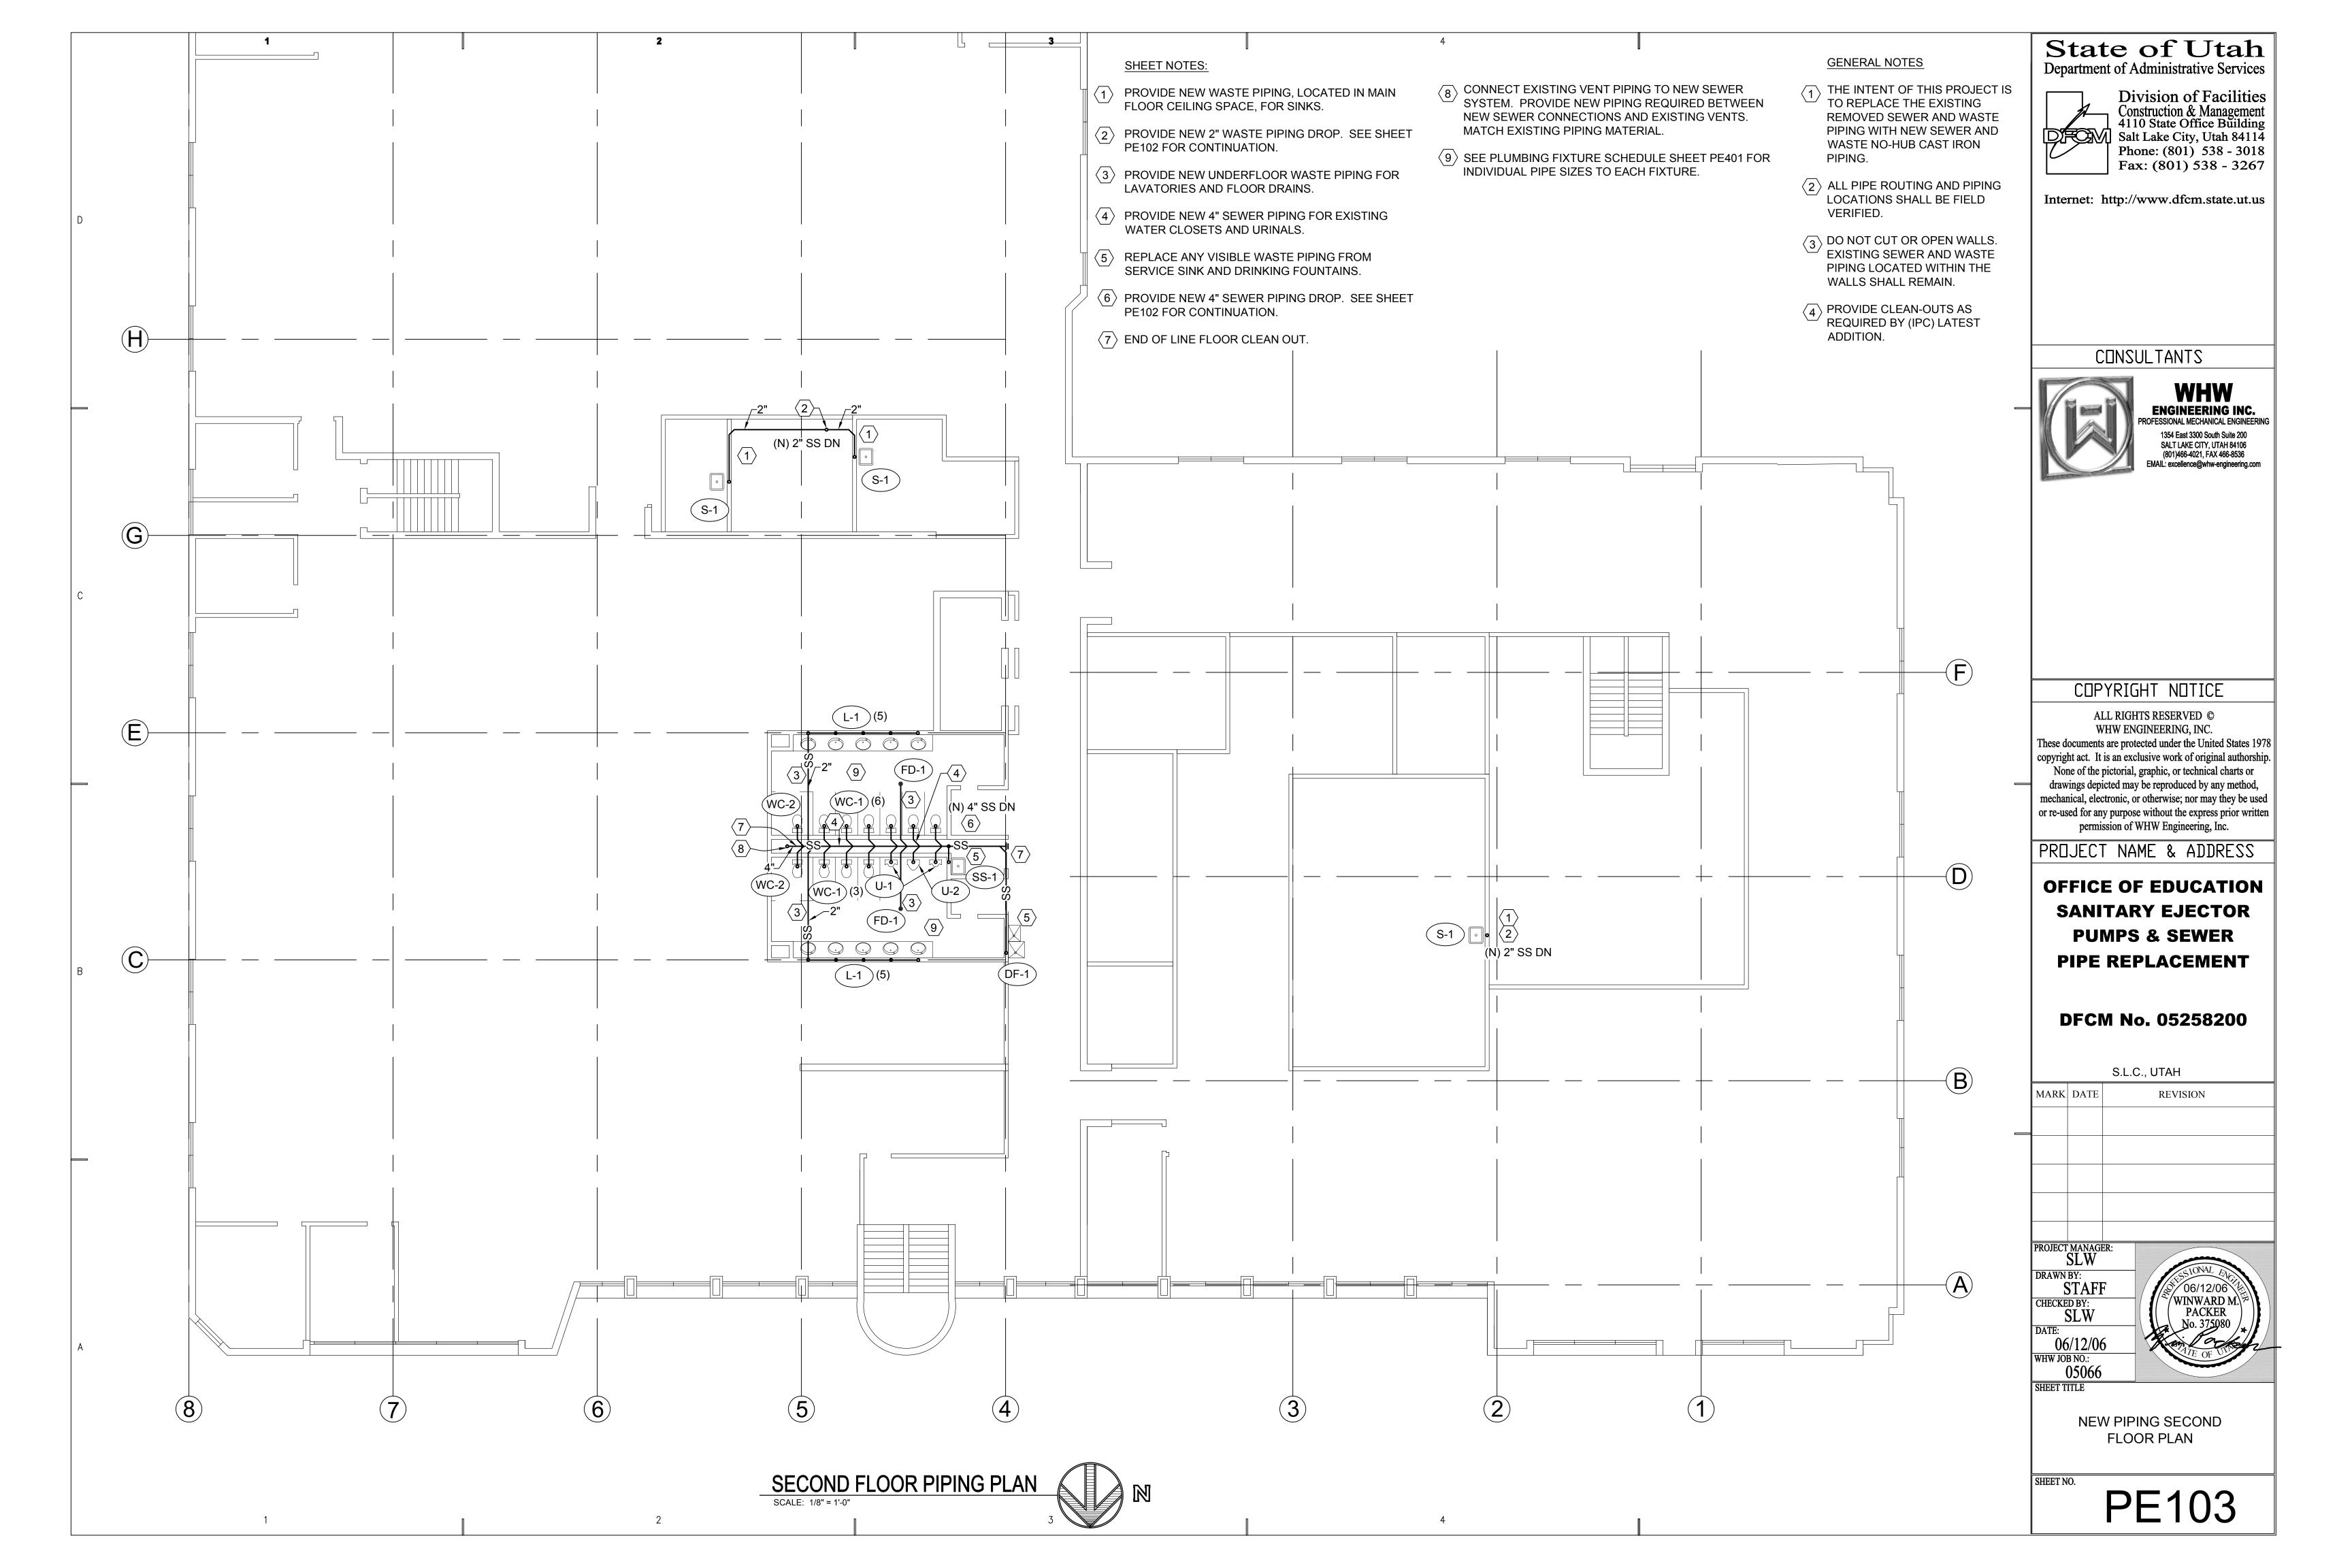
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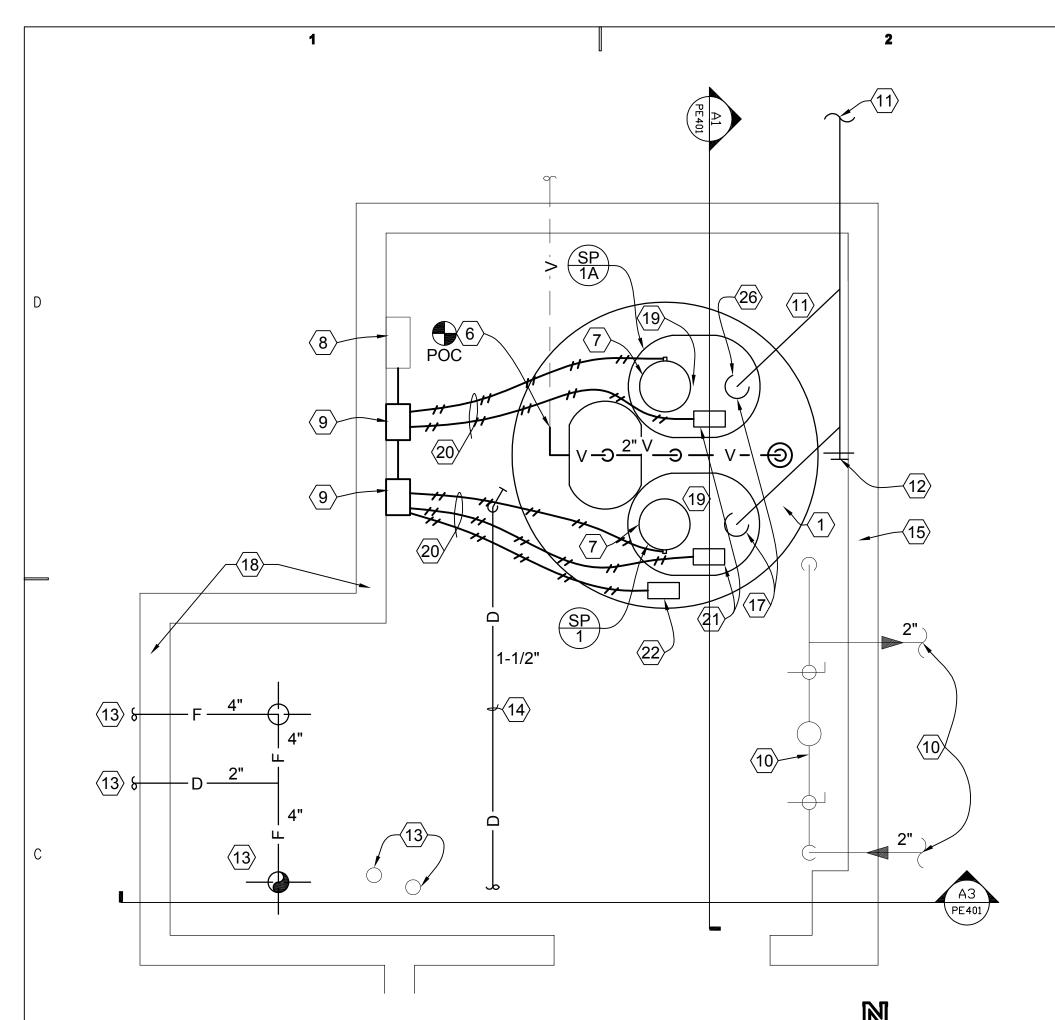
SEWAGE PIPING **DEMOLITION DETAILS**

PD402






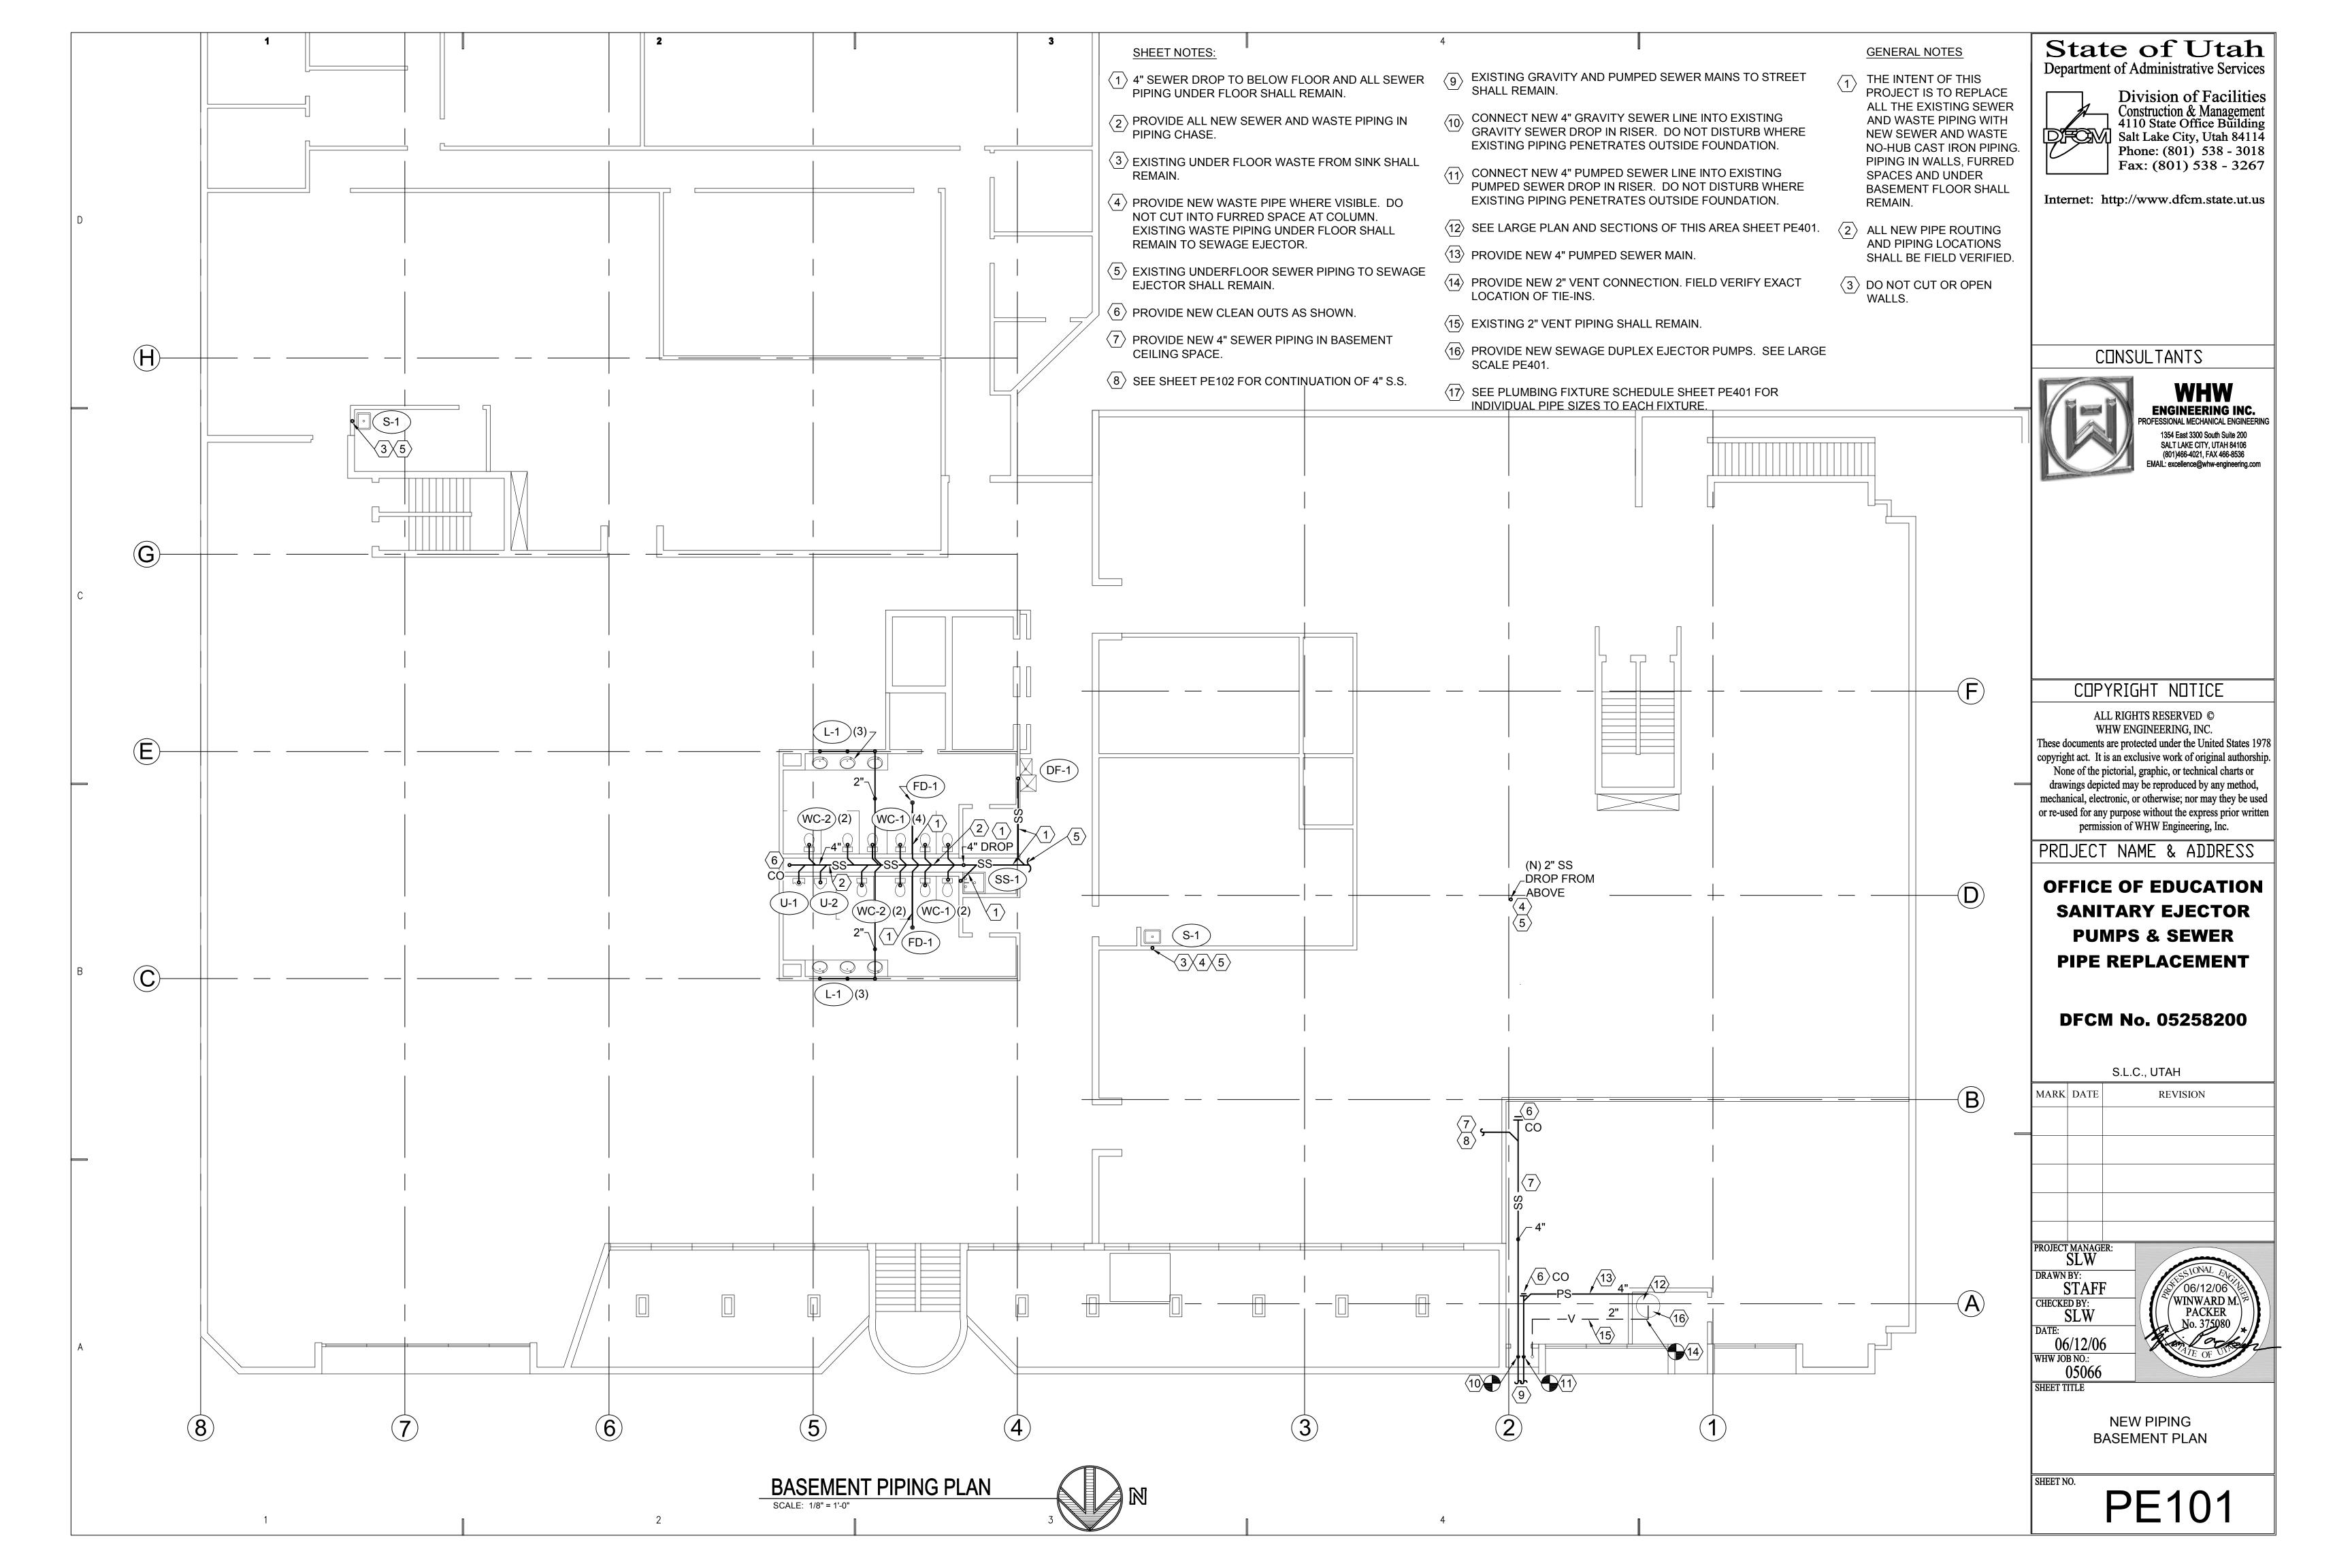


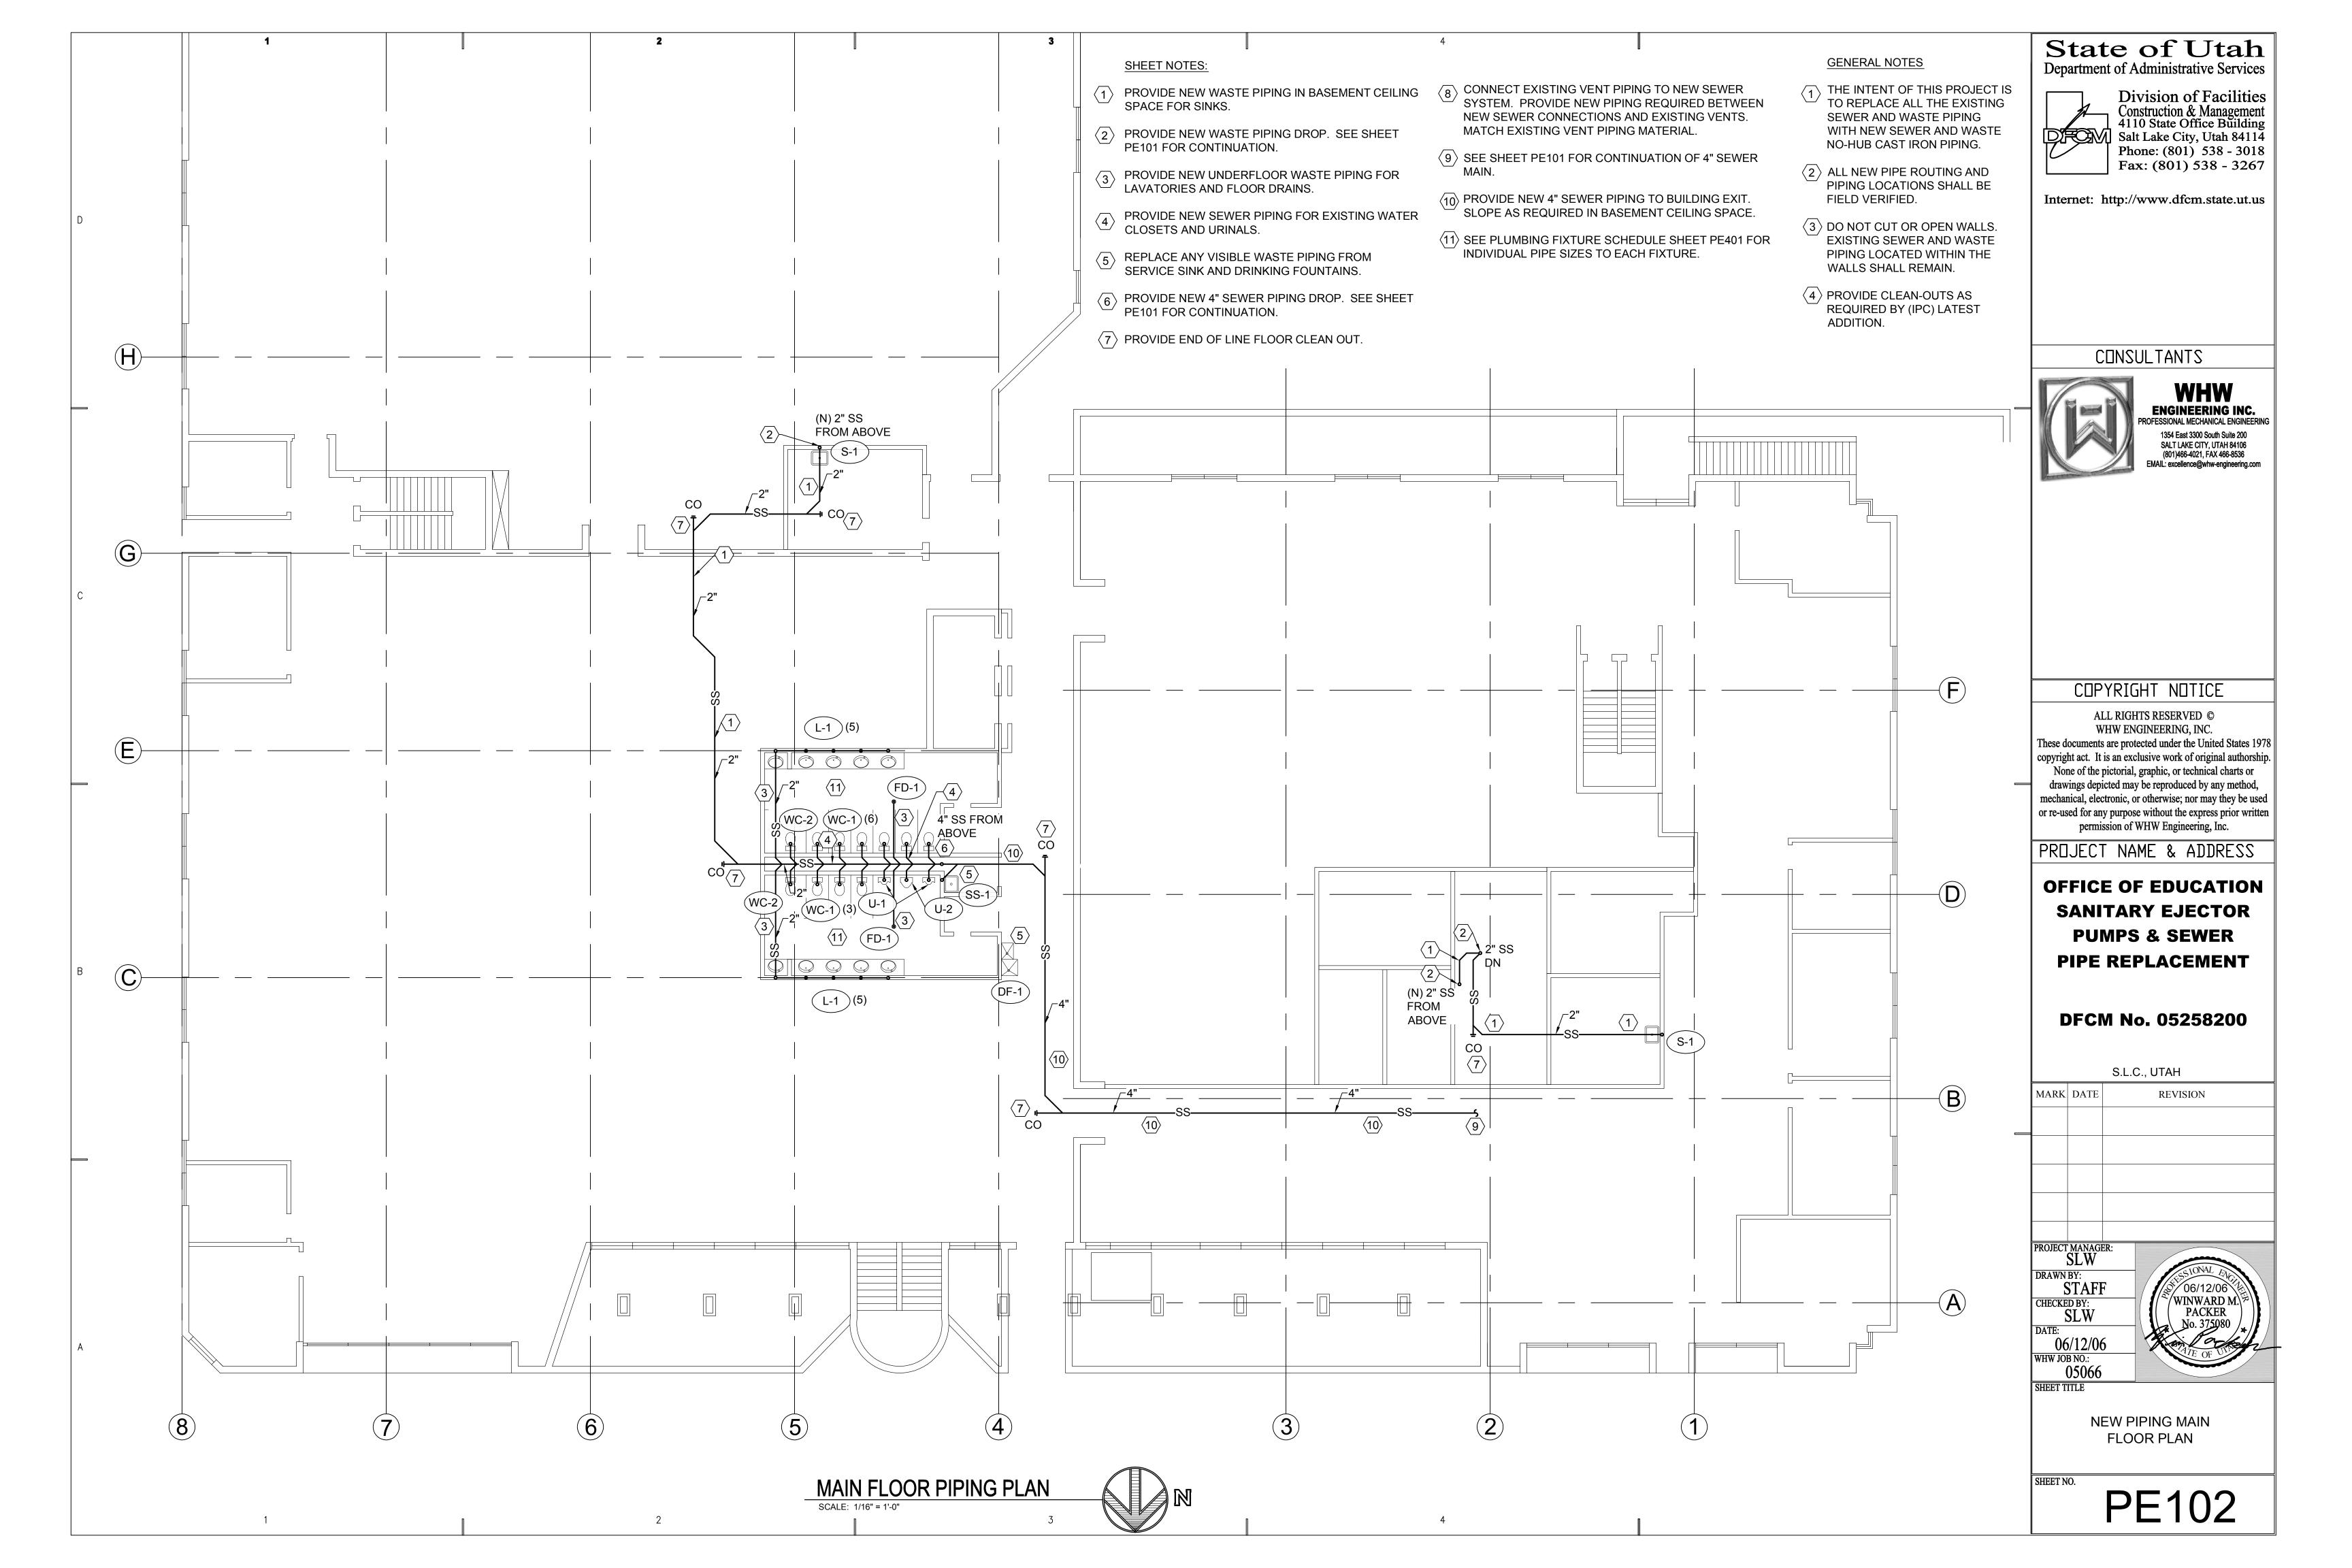



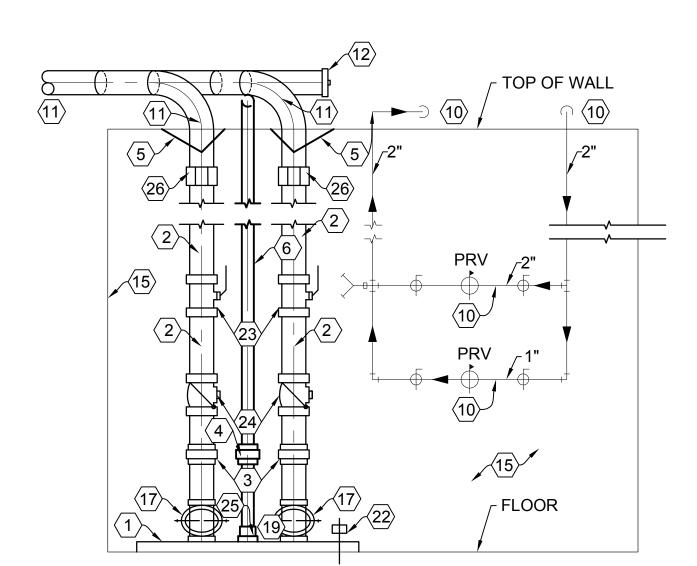

BASEMENT SEWER EJECTOR ROOM PUMP PIPING SECTION LOOKING SOUTH SCALE: 3/4" = 1'-0"

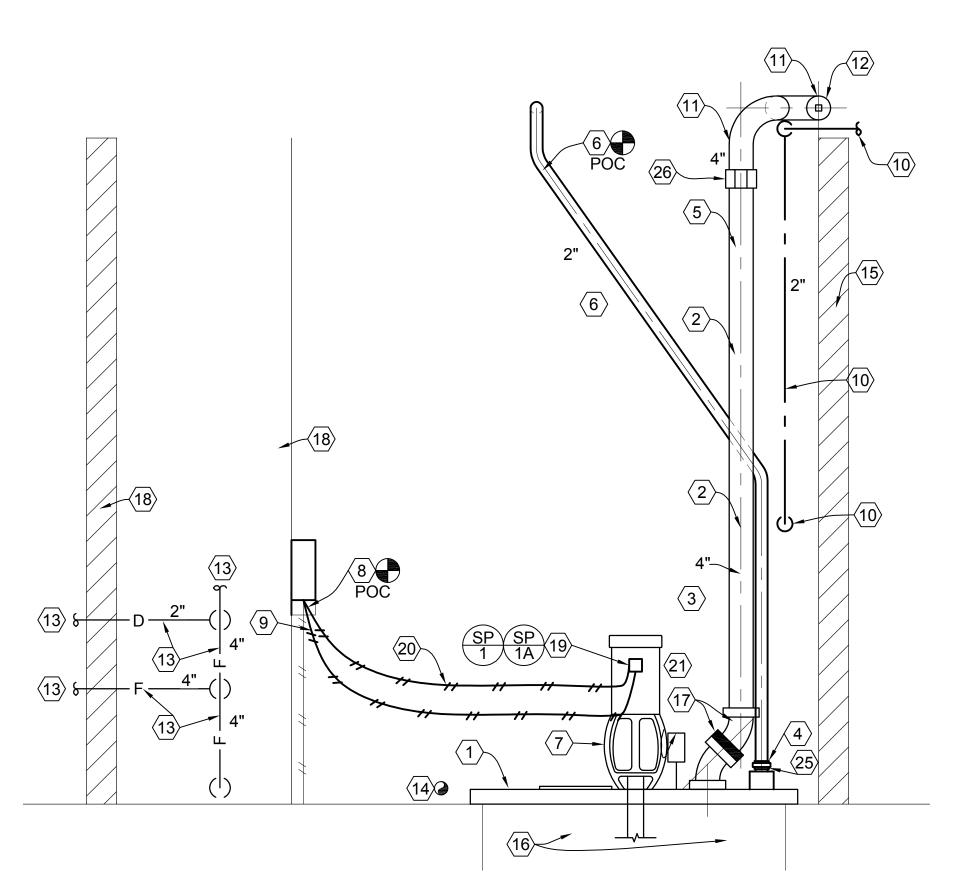

BASEMENT SEWER EJECTOR ROOM PUMP PIPING SECTION-LOOKING EAST

SCALE: 3/4" = 1'-0"

PLUMBING FIXTURE SCHEDULE									
SYMBOL	FIXTURE	ı	NDIVIDUAL L	INE SIZES	REMARKS				
		TRAP	P WASTE VENT						
WC-1)	WATER CLOSET	4"	4"	2"					
WC-2	WC-2 WATER CLOSET U-1 URINAL		4"	2"					
<u>U-1</u>			3"	2"					
U-2	URINAL	3"	3"	2"					
(L-1)	LAVATORY	1-1/2"	2"	1-1/2"					
FD-1	FD-1 FLOOR DRAIN		3"	2"					
DF-1	DRINKING FOUNTAIN	1-1/2"	1-1/2"	1-1/2"					
<u>S-1</u>	SINK	2"	2"	1-1/2"	1-1/2"@ FIXTURE				
(SS-1) SERVICE SINK		3"	3"	2"					

	PUMP SCHEDULE											
SYMBOL	TYPE	GPM	FT. HEAD	RPM	SUCTION SIZE	DISCHARGE SIZE	MOTOR		SIZE	SERVICE	COMMENTS	SCHEDULE NOTES
							V - Ø - Hz	HP				
SP SP 1 1A	VERTICAL CENTRIFUGAL PUMP	125	20	1750	3" SOLIDS	4" FLANGED	460/3/60	2.0	4X4x7	SEWAGE EJECTOR	AURORA 632 FS	1245

SHEET NOTES

- $\langle 1 \rangle$ PROVIDE NEW SUMP COVER TO FIT EXISTING SUMP. COVER SHALL FIT AIR TIGHT OVER EXISTING SUMP. CONTRACTOR AND SUPPLIER SHALL FIELD VERIFY EXACT SIZE OF EXISTING SUMP DEPTH AND COVER DIAMETER.
- 2 PROVIDE NEW 4" GALVANIZED DISCHARGE PIPING
- $\langle 3 \rangle$ PROVIDE 4" GALVANIZED UNION.
- 4 PROVIDE 2" GALVANIZED UNION.
- 5 RE-USE EXISTING SEISMIC CABLE FOR SUPPORTING PIPING AT TOP OF RISERS.
- 6 PROVIDE NEW 2" GALVANIZED VENT PIPING -CONNECT TO EXISTING 2" VENT LINE AT THIS LOCATION.
- (7) PROVIDE NEW SEWAGE EJECTOR PUMPS. SEE SCHEDULE FOR CAPACITIES THIS SHEET.
- (8) EXISTING DISCONNECT SHALL REMAIN.
- 9 PROVIDE NEW PUMP STARTERS. AUTO-OFF HAND WITH RED LIGHT RUN STATUS.
- $\langle 10 \rangle$ EXISTING CULINARY WATER PRV STATION AND PIPING SHALL REMAIN.
- (11) PROVIDE NEW 4" CI PIPING. SEE SHEET PE101 FOR CONTINUATION.
- (12) PROVIDE NEW END OF MAIN CLEAN-OUT.
- (13) EXISTING FIRE SPRINKLING RISERS, PIPING, ETC. SHALL REMAIN. PROTECT DURING CONSTRUCTION.
- (14) SPRINKLER DRAIN LINE SHALL BE REMOVED DURING CONSTRUCTION AND REPLACED AFTER NEW SUMP COVER AND PUMPS ARE INSTALLED.
- (15) EXISTING SHEET ROCK INTERIOR WALL NOT FULL HEIGHT.
- $\langle 16 \rangle$ EXISTING SUMP TO REMAIN.
- ⟨17⟩ PROVIDE 4" 125# COMPANION FLANGE CONNECTION WITH 4" SCREWED FITTING ON OUTLET OF FLANGE.
- (18) EXTERIOR WALL
- (19) PROVIDE NEW DUPLEX SEWAGE EJECTOR PUMPS, COVER, CONTROLS, ETC.
- TO NEW PUMP CONNECTIONS.

20 PROVIDE NEW LIQUID TIGHT 3/4" FLEX CONDUIT

- (21) NEW FLOAT LEVEL CONTROLLER FLOW SWITCH SHALL BE PROVIDED WITH PUMP PACKAGE. INSTALL PER MANUFACTURER'S INSTRUCTIONS.
- 22 PROVIDE NEW HIGH LEVEL ALARM WITH PUMP PACKAGE. INSTALL PER MANUFACTURER'S INSTRUCTIONS.
- 23 PROVIDE NEW 4" SCREWED BALL VALVE CAST BRONZE - KITZ CODE #58 AKSZA OR LUG TYPE 4" BUTTERFLY VALVE WITH COMPANION FLANGES MAY ALSO BE USED. KITZ-150 PSI DJ SERIES, DUCTILE IRON WITH LEVER OPERATOR.
- 24 PROVIDE NEW 4" SCREWED CHECK VALVE KITZ CLASS 125 - BRONZE T PATTERN SWING. CODE #04AKR.
- 25 PROVIDE 4" X 2" REDUCER.
- (26) PROVIDE 4" GALVANIZED TO 4" CAST IRON CONNECTION.
- (27) EXISTING 2" VENT PIPING. SEE SHEET PE101 FOR CONTINUATION.

State of Utah Department of Administrative Services



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DFCM No. 05258200

S.L.C., UTAH

MARK	DATE	REVISION							

PROJECT MANAGER: SLW DRAWN BY: STAFF 9 06/12/06 /WINWARD M CHECKED BY: PACKER SLW WHW JOB NO.:

05066 SHEET TITLE

> LARGE SCALE EJECTOR **ROOM PIPING** PLAN AND SECTIONS

PE401


$\stackrel{\textstyle \frown}{}$ ALL PUMPS SHALL BE SIZED IN THE FLAT PART OF	THE CURVE.

- 2) SEE SPECIFICATIONS FOR OTHER APPROVED MANUFACTURERS. (3) LENGTH OF PUMP. FEILD VERIFY - SEE NOTE #1 / PE401
- 4 EXISTING SUMP PIT SHALL REMAIN.
- (5) SUPPLY PUMP PACKAGE WITH LEVEL CONTROL FLOW SWITCH, HIGH LEVEL ALARM AND ALTERNATOR.

1 16 $\langle 1 \rangle \langle 16 \rangle$ 000 000 4 NEW COVER _FLOOR


ELECTRICAL AND CONTROL DIAGRAM

SCALE: 1" = 1'-0"

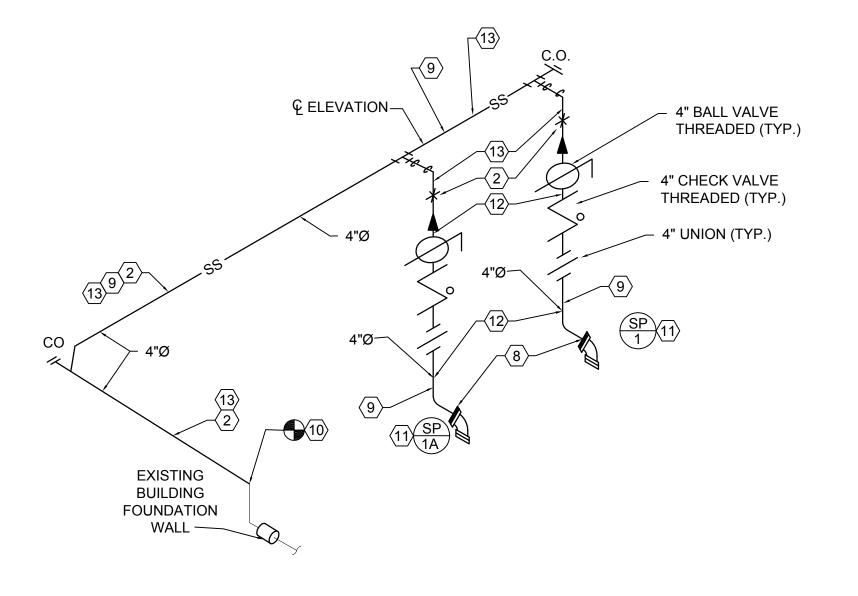

SEWER DISCHARGE PIPING - PUMPS CP1A & CP1B

SCALE: NONE

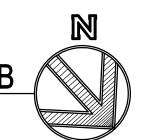


SHEET NOTES

- (1) PROVIDE NEW ELECTRICAL NEMA SIZE 1 STARTERS FOR NEW SEWER EJECTOR PUMPS. MOUNT IN SAME LOCATION AS EXISTING REMOVED STARTERS.
- (2) ROUTE NEW 4" GALVANIZED PIPING TO POINT ABOVE BALL VALVE. INSTALL 4" CAST IRON NO-HUB FROM THIS POINT TO BUILDING EXIT.
- PROVIDE NEW 3/4" LIQUID TIGHT FLEXIBLE CONDUIT. WIRING FOR MOTORS SHALL BE 3# 12 COPPER WIRES.
- 4 PROVIDE NEW CONNECTIONS TO NEW PUMPS AND NEW LEVEL CONTROLLERS. INSTALL IN ACCORDANCE WITH NEC 2005.
- $\langle 5 \rangle$ PROVIDE NEW LEVEL CONTROLLERS WITH NEW PUMP PACKAGE. INSTALL IN ACCORDANCE WITH MANUFACTURER'S INSTRUCTIONS.
- (6) PROVIDE NEW HIGH LEVEL ALARM IN THE LOCATION INDICATED ON THE NEW SUMP COVER.
- $\langle 7 \rangle$ WALL OF EXISTING SEWER SUMP.
- $\langle 8 \rangle$ PROVIDE 4" -125# COMPANION FLANGE WITH 4" SCREWED FITTING ON OUTLET OF FLANGE.
- 9 PROVIDE NEW 4" PUMPED SEWER LINE FROM NEW PUMPS TO PIPING CONNECTION AT EXISTING PUMPED SEWER LINE AT BUILDING
- (10) CONNECT NEW 4" PUMPED PIPING FROM NEW SEWAGE PUMPS TO EXISTING 4" SANITARY SEWER AT BUILDING EXIT. FIELD VERIFY LOCATION OF CONNECTION AND EXISTING CONDITIONS.
- (11) PROVIDE NEW SEWER EJECTOR PUMPS AND COVER. RE-USE EXISTING SEWAGE SUMP. FIELD VERIFY SIZE AND DEPTH OF PIT BEFORE ORDERING NEW PUMPS.
- (12) PROVIDE NEW 4" GALVANIZED PIPING.
- (13) PROVIDE NEW 4" CAST IRON NO HUB PIPING AND CLEAN-OUTS.
- (14) EXISTING POWER SOURCE SHALL REMAIN.
- (15) EXISTING DISCONNECT SHALL REMAIN.
- 16 PROVIDE PUMP STARTERS WITH AUTO-OFF-HAND, AND WITH RED LIGHT RUN

State of Utah Department of Administrative Services



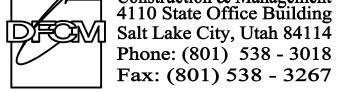

Internet: http://www.dfcm.state.ut.us

CONSULTANTS



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PROJECT NAME & ADDRESS

OFFICE OF EDUCATION **SANITARY EJECTOR PUMPS & SEWER** PIPE REPLACEMENT

DFCM No. 05258200

				S.L.	C., UTA	АН
		MARK	DATE		RE	EVISION
•						
		PROJECT MANAGER: SLW				
		DRAWN BY: STAFF CHECKED BY:				06/12/06 WINWARD M
						WINWARD M.\♥\

WHW JOB NO.:

05066

SEWER PIPING AND ELECTRICAL DETAILS

PE501